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#### INFORMATION CALENDAR November 14, 2023

To: Honorable Mayor and Members of the City Council

From: Dee Williams-Ridley, City Manager

Submitted by: Jordan Klein, Director, Planning and Development Department

Subject: LPO NOD: 1960 San Antonio Avenue/645 Arlington Avenue, #LMSAP2022-

0005

#### INTRODUCTION

The attached Landmarks Preservation Commission Notice of Decision (NOD) is presented to the Mayor and City Council pursuant to Berkeley Municipal Code/Landmarks Preservation Ordinance (BMC/LPO) Section 3.24.240.A, which requires that "a copy of the Notice of Decision shall be filed with the City Clerk and the City Clerk shall present said copy to the City Council at its next regular meeting."

#### **CURRENT SITUATION AND ITS EFFECTS**

The Landmark Preservation Commission (LPC/Commission) has approved a Structural Alteration Permit (SAP) for the subject City Landmark property. This action is subject to a 15-day appeal period that began on October 31, 2023, after being postponed from August 29, 2023.

#### **BACKGROUND**

BMC/LPO Section 3.24.300 allows City Council to review any action of the Landmarks Preservation Commission in granting or denying a Structural Alteration Permit. For Council to review the decision on its merits, Council must appeal the Notice of Decision. To do so, a Council member must move this Information Item to Action and then move to set the matter for hearing on its own. Such action must be taken within 15 days of the mailing of the Notice of Decision, or by November 14, 2023. Such certification to Council shall stay all proceedings in the same manner as the filing of an appeal.

If the Council chooses to appeal the action of the Commission, then a public hearing will be set. The Council must then rule on the designation within 30 days of closing the hearing, otherwise the decision of the Commission is automatically deemed affirmed.

Unless the Council wishes to review the determination of the Commission and make its own decision, the attached NOD is deemed received and filed.

At their meeting on September 12, 2023, City Council received an Information Report citing this LPC decision and announcing the conclusion of the 15-day appeal period.

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However, staff postponed the appeal period to commence on October 31, 2023 in order to correct a clerical oversight in the distribution of the public notices.

#### **ENVIRONMENTAL SUSTAINABILITY & CLIMATE IMPACTS**

Landmark designation provides opportunities for the adaptive re-use and rehabilitation of historic resources within the City. The rehabilitation of these resources, rather than their removal, achieves construction and demolition waste diversion, and promotes investment in existing urban centers.

#### **POSSIBLE FUTURE ACTION**

The Council may choose to appeal the decision, in which case it would conduct a public hearing at a future date.

#### FISCAL IMPACTS OF POSSIBLE FUTURE ACTION

There are no known fiscal impacts associated with this action.

#### **CONTACT PERSON**

Fatema Crane, Principal Planner, Planning and Development Department, 510-981-7410

#### Attachments:

1: Notice of Decision – 1960 San Antonio Avenue/645 Arlington Avenue, #LMSAP2022-0005

Attachment 1, Part 1



LANDMARKS

PRESERVATION

COMMISSION

Notice of Decision

DATE OF BOARD DECISION: June 1, 2023

DATE NOTICE MAILED: August 28, 2023October 30, 2023

APPEAL PERIOD EXPIRATION: August 28, 2023November 14, 2023

EFFECTIVE DATE OF PERMIT (Barring Appeal or Certification): September 12, 2023November 15, 2023<sup>1</sup>

## 1960 San Antonio Avenue/645 Arlington Avenue – Spring Estate

Structural Alteration Permit #LMSAP2022-0005

to restore the terrace, remove the non-historic building addition, and repair railings and walkways of the Spring Mansion; demolish the detached, non-historic garage and construct a new ten-car garage; demolish and replace the non-historic driveway, retaining walls and stairs on the east side of the property; construct a new, detached pool house, excavate and install a new swimming pool; and complete landscape improvements at a City Landmark residential property in the Hillside neighborhood, contingent upon rehabilitation of the historic gymnasium building.

The Landmarks Preservation Commission of the City of Berkeley, after conducting a public hearing, **APPROVED** the following request:

<sup>1</sup> Pursuant to BMC Chapter 3.24, the City Council may "certify" any decision of the LPC for review, which has the same effect as an appeal. In most cases, the Council must certify the LPC decision during the 14-day appeal period. However, pursuant to BMC Section 1.04.070, if any portion of the appeal period falls within a Council recess, the deadline for Council certification is suspended until the first Council meeting after the recess, plus the number of days of the appeal period that occurred during the recess, minus one day. If there is no appeal or certification, the Use Permit becomes effective the day after the certification deadline has passed.

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Structural Alteration Permit

**APPLICANT:** Bahadour Zarrin

Paymun Building & Development

25 Orinda Way, Suite 200

Orinda, CA 94563

**ZONING DISTRICT:** Single Family Residential District, Hillside Overlay (R-1H)

**ENVIRONMENTAL REVIEW STATUS:** Categorically exempt under the California Environmental Quality Act Guidelines, Sections 15303 and 15331 of the CEQA Guidelines for New Construction and Historical Resource Rehabilitation.

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#### The application materials for this project is available online at:

https://berkeleyca.gov/construction-development/land-use-development/zoning-projects or https://permits.cityofberkeley.info/CitizenAccess/Default.aspx

## FINDINGS FOR FINAL ACTION AND APPROVED PLANS ARE ATTACHED TO THIS NOTICE

**COMMISSION VOTE: 8-0-0-1** 

YES: ADAMS, CRANDALL, ENCHILL, FINACOM, LINVILL, MONTGOMERY,

SCHWARTZ, TWU

NO: NONE

**ABSTAIN**: NONE

**ABSENT**: LEUSCHNER

#### TO APPEAL THIS DECISION (see Section 3.24.300 of the Berkeley Municipal Code):

To appeal a decision of the Landmarks Preservation Commission to the City Council you must:

- 1. Submit a letter clearly and concisely setting forth the grounds for the appeal to the City Clerk, located at 2180 Milvia Street, 1st Floor, Berkeley. The City Clerk's telephone number is (510) 981-6900.
  - a. Pursuant to BMC Section 3.24.300.A, an appeal may be taken to the City Council by the application of the owners of the property or their authorized agents, or by the

LANDMARKS PRESERVATION COMMISSION NOTICE OF DECISION #LMSAP2022-0005 1960 San Antonio Avenue/645 Arlington Avenue October 30, 2023 Page 3 of 5

application of at least fifty residents of the City aggrieved or affected by any determination of the commission made under the provisions of Chapter 3.24.

- 2. Submit the required fee (checks and money orders must be payable to 'City of Berkeley'):
  - a. The basic fee for persons other than the applicant is \$500. This fee may be reduced to \$100 if the appeal is signed by persons who lease or own at least 50 percent of the parcels or dwelling units within 300 feet of the project site, or at least 25 such persons (not including dependent children), whichever is less. Signatures collected per the filing requirement in BMC Section 3.24.300.A may be counted towards qualifying for the reduced fee, so long as the signers are qualified. The individual filing the appeal must clearly denote which signatures are to be counted towards qualifying for the reduced fee.
  - b. The fee for appeals of affordable housing projects (defined as projects which provide 50 percent or more affordable units for households earning 80% or less of Area Median Income) is \$500, which may not be reduced.
  - c. The fee for all appeals by Applicants is \$2500.
- 3. The appeal must be received prior to 5:00 p.m. on the "APPEAL PERIOD EXPIRATION" date shown above (if the close of the appeal period falls on a weekend or holiday, then the appeal period expires the following business day).

If no appeal is received, the landmark permit will be final on the first business day following expiration of the appeal period.

#### **NOTICE CONCERNING YOUR LEGAL RIGHTS:**

If you object to this decision, the following requirements and restrictions apply:

- 1. If you challenge this decision in court, you may be limited to raising only those issues you or someone else raised at the public hearing described in this notice, or in written correspondence delivered to the Landmarks Preservation Commission at, or prior to, the public hearing.
- You must appeal to the City Council within fifteen (15) days after the Notice of Decision of the action of the Landmarks Preservation Commission is mailed. It is your obligation to notify the Land Use Planning Division in writing of your desire to receive a Notice of Decision when it is completed.
- 3. Pursuant to Code of Civil Procedure Section 1094.6(b) and Government Code Section 65009(c)(1), no lawsuit challenging a City Council decision, as defined by Code of Civil Procedure Section 1094.6(e), regarding a use permit, variance or other permit may be filed more than ninety (90) days after the date the decision becomes final, as defined in Code of Civil Procedure Section 1094.6(b). Any lawsuit not filed within that ninety (90) day period will be barred.
- 4. Pursuant to Government Code Section 66020(d)(1), notice is hereby given to the applicant that the 90-day protest period for any fees, dedications, reservations, or other exactions

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1960 San Antonio Avenue/645 Arlington Avenue

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included in any permit approval begins upon final action by the City, and that any challenge must be filed within this 90-day period.

- 5. If you believe that this decision or any condition attached to it denies you any reasonable economic use of the subject property, was not sufficiently related to a legitimate public purpose, was not sufficiently proportional to any impact of the project, or for any other reason constitutes a "taking" of property for public use without just compensation under the California or United States Constitutions, your appeal of this decision must include the following information:
  - A. That this belief is a basis of your appeal.
  - B. Why you believe that the decision or condition constitutes a "taking" of property as set forth above.
  - C. All evidence and argument in support of your belief that the decision or condition constitutes a "taking" as set forth above.

If you do not do so, you will waive any legal right to claim that your property has been taken, both before the City Council and in court.

#### **PUBLIC COMMENT:**

Communications to Berkeley boards, commissions or committees are public record and will become part of the City's electronic records, which are accessible through the City's website. Please note: e-mail addresses, names, addresses, and other contact information are not required, but if included in any communication to a City board, commission or committee, will become part of the public record. If you do not want your e-mail address or any other contact information to be made public, you may deliver communications via U.S. Postal Service or in person to the secretary of the relevant board, commission or committee. If you do not want your contact information included in the public record, please do not include that information in your communication. Please contact the secretary to the relevant board, commission or committee for further information.

#### **FURTHER INFORMATION:**

Questions about the project should be directed to the project planner, Allison Riemer, at (510) 981-7433 or <a href="mailto:ariemer@cityofberkeley.info">ariemer@cityofberkeley.info</a>. All project application materials, including full-size plans, may be viewed at the Permit Service Center (Zoning counter), 1947 Center Street, 3<sup>rd</sup> Fl., during regular business hours.

#### **ATTACHMENTS:**

- 1. Findings for Final Action
- 2. Project Plans, received MAY 15, 2023

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ATTEST:

Fatema Crane, Secretary Landmarks Preservation Commission

cc: City Clerk

Applicant: Bahadour Zarrin, Paymun Building & Development, 25 Orinda

Way, Suite 200, Orinda, CA 94563

Property Owner: Abbas Mash, 18 Deer Oaks Drive, Pleasanton, CA 94588

## Findings and Conditions

# 1960 San Antonio Avenue/645 Arlington Avenue – The Spring Estate

Structural Alteration Permit (#LMSAP2022-0005) to restore the terrace, remove the non-historic building addition, and repair railings and walkways of the Spring Mansion; demolish the detached, non-historic garage and construct a new ten-car garage; demolish and replace the non-historic driveway, retaining walls and stairs on the east side of the property; construct a new, detached pool house, excavate and install a new swimming pool; and complete landscape improvements at a City Landmark residential property in the Hillside neighborhood, contingent upon rehabilitation of the historic gymnasium building.

#### **CEQA FINDINGS**

The project is limited to design review and historic preservation consideration and is 1. categorically exempt from the provisions of the California Environmental Quality Act (CEQA, Public Resources Code §21000, et seq. and California Code of Regulations, Section 15331 pursuant ("Historic §15000, seq.) to Restoration/Rehabilitation") and Section 15303 ("New Construction") of the CEQA Guidelines. Furthermore, none of the exceptions in CEQA Guidelines Section 15300.2 apply, as follows: (a) the site is not located in an environmentally sensitive area, (b) there are no cumulative impacts, (c) there are no significant effects, (d) the project is not located near a scenic highway, and (e) the project site is not located on a hazardous waste site pursuant to Government Code Section 65962.5.

#### SECRETARY OF THE INTERIOR'S STANDARDS FINDINGS

Regarding the Secretary of the Interior's Standards for Rehabilitation, the Landmarks Preservation Commission of the City of Berkeley makes the following findings:

- 1. The proposal to rehabilitate the property and add additional residential accessory structures would retain and continue the historic residential use of the property.
- 2. The historic character of the Spring Estate will be retained and preserved with proposed repairs and replacement of distinctive features, such as the concrete walkways, retaining walls, railings, and balusters north, south, and west of the mansion. The proposed new buildings and structures would generally be located south of the mansion and, would not be readily visible from the public right-of-way.

- 3. This property will continue to be recognized as a physical record of its time, place, and use as a result of the approved project. None of the proposed alterations are found to create a false sense of historical development. The proposed garage, pool house, and pool will have a contemporary design, and will be distinguished from the historic components of the estate.
- 4. No changes to this property that have acquired historical significance in their own right, have been identified, or are of concern for this project.
- 5. This project would not negatively affect distinctive materials, features, finishes, and construction techniques or examples of craftsmanship that characterize this property.
- 6. Deteriorated historic features of this property will be repaired where feasible, and replaced when repair is not feasible. The historic gymnasium will be rehabilitated (see Condition of Approval 13).
- 7. Chemical treatments are not anticipated; however, if they are appropriate, they will be undertaken using the gentlest means possible. Treatments that cause damage to historic materials are prohibited by the Conditions herein.
- 8. Any archeological resources at this site would be protected and/or preserved in place per the City's standard conditions and procedures for new construction and excavation.
- 9. Overall, the new construction would be differentiated and yet compatible with the Spring Estate. The proposed project would retain and would not destroy the historic materials and features of the Spring Estate. The new structures have been designed in a contemporary style with selected materials and finishes that are different than -- and also compatible with -- the Beaux-Arts mansion and features.
- 10. The proposed new buildings would be constructed south of the mansion, near the side property line; if the new buildings were removed in the future, the essential form and integrity of the Spring Estate would be unimpaired.

#### LANDMARK PRESERVATION ORDINANCE FINDINGS

- 1. As required by Section 3.24.260 of the Landmarks Preservation Ordinance, the Commission finds that the proposed work is appropriate for and consistent with the purposes of the Ordinance, and will preserve and enhance the characteristics and features specified in the designation for this property, because:
  - A. The proposal includes rehabilitation of the concrete features around the mansion, and would not adversely affect the historic exterior features.
  - B. The new work would not be readily visible from the public right-of-way, and would be subordinate to the mansion. Therefore, the proposed changes would not adversely affect the special character of this estate designed by John Hudson Thomas.
  - C. As conditioned herein, the historic gymnasium building will be rehabilitated and the property brought into compliance with the Ordinance requirement to maintain

designated sites in good repair; BMC Section 3.24.290.

#### STANDARD CONDITIONS

The following conditions, as well as all other applicable provisions of the Landmarks Preservation Ordinance, apply to this Permit:

#### 1. Conditions Shall be Printed on Plans

The conditions of this Permit shall be printed on the *second* sheet of each plan set submitted for a building permit pursuant to this Permit, under the title 'Structural Alteration Permit Conditions'. *Additional sheets* may also be used if the *second* sheet is not of sufficient size to list all of the conditions. The sheet(s) containing the conditions shall be of the same size as those sheets containing the construction drawings; 8-1/2" by 11" sheets are not acceptable.

#### 2. Plans and Representations Become Conditions

Except as specified herein, the site plan, floor plans, building elevations and/or any additional information or representations, whether oral or written, indicating the proposed structure or manner of operation submitted with an application or during the approval process are deemed conditions of approval.

#### 3. Subject to All Applicable Laws and Regulations

The approved construction is subject to, and shall comply with, all applicable City Ordinances and laws and regulations of other governmental agencies. Prior to installation, the applicant shall obtain Use Permit approval in accordance with BMC Section 23C.17 (Wireless Telecommunication). Prior to construction, the applicant shall identify and secure all applicable permits from the Building and Safety Division, Public Works Department and other affected City divisions and departments.

#### 4. Exercise and Expiration of Permits (BMC Section 23.404.060.C)

- A. A permit authorizing a land use is exercised when both a valid City business license is issued (if required) and the land use is established on the property.
- B. A permit authorizing construction is exercised when both a valid City building permit (if required) is issued and construction has lawfully begun.
- C. The Zoning Officer may declare a permit lapsed if it is not exercised within one year of its issuance, except if the applicant has applied for a building permit or has made a substantial good faith effort to obtain a building permit and begin construction. The Zoning Officer may declare a permit lapsed only after 14 days written notice to the applicant. A determination that a permit has lapsed may be appealed to the ZAB in accordance with Chapter 23.410 (Appeals and Certification).
- D. A permit declared lapsed shall be void and of no further force and effect. To establish the use or structure authorized by the lapsed permit, an applicant must apply for and receive City approval of a new permit.

#### 5. Indemnification Agreement

The applicant shall hold harmless, defend, and indemnify the City of Berkeley and its

officers, agents, and employees against any and all liability, damages, claims, demands, judgments or other losses (including without limitation, attorney's fees, expert witness and consultant fees and other litigation expenses), referendum or initiative relating to, resulting from or caused by, or alleged to have resulted from, or caused by, any action or approval associated with the project. The indemnity includes without limitation, any legal or administrative challenge, referendum or initiative filed or prosecuted to overturn, set aside, stay or otherwise rescind any or all approvals granted in connection with the Project, any environmental determination made for the project and granting any permit issued in accordance with the project. This indemnity includes, without limitation, payment of all direct and indirect costs associated with any action specified herein. Direct and indirect costs shall include, without limitation, any attorney's fees, expert witness and consultant fees, court costs, and other litigation fees. City shall have the right to select counsel to represent the City at Applicant's expense in the defense of any action specified in this condition of approval. City shall take reasonable steps to promptly notify the Applicant of any claim, demand, or legal actions that may create a claim for indemnification under these conditions of approval.

- 6. Halt Work/Unanticipated Discovery of Tribal Cultural Resources. In the event that cultural resources of Native American origin are identified during construction, all work within 50 feet of the discovery shall be redirected. The project applicant and project construction contractor shall notify the City Planning Department within 24 hours. The City will again contact any tribes who have requested consultation under AB 52, as well as contact a qualified archaeologist, to evaluate the resources and situation and provide recommendations. If it is determined that the resource is a tribal cultural resource and thus significant under CEQA, a mitigation plan shall be prepared and implemented in accordance with State guidelines and in consultation with Native American groups. If the resource cannot be avoided, additional measures to avoid or reduce impacts to the resource and to address tribal concerns may be required.
- 7. <u>Archaeological Resources (Ongoing throughout demolition, grading, and/or construction)</u>. Pursuant to CEQA Guidelines Section 15064.5(f), "provisions for historical or unique archaeological resources accidentally discovered during construction" should be instituted. Therefore:
  - A. In the event that any prehistoric or historic subsurface cultural resources are discovered during ground disturbing activities, all work within 50 feet of the resources shall be halted and the project applicant and/or lead agency shall consult with a qualified archaeologist, historian or paleontologist to assess the significance of the find.
  - B. If any find is determined to be significant, representatives of the project proponent and/or lead agency and the qualified professional would meet to determine the appropriate avoidance measures or other appropriate measure, with the ultimate determination to be made by the City of Berkeley. All significant cultural materials recovered shall be subject to scientific analysis, professional museum curation, and/or a report prepared by the qualified professional according to current professional standards.
  - C. In considering any suggested measure proposed by the qualified professional, the project applicant shall determine whether avoidance is necessary or feasible in light of

- factors such as the uniqueness of the find, project design, costs, and other considerations.
- D. If avoidance is unnecessary or infeasible, other appropriate measures (e.g., data recovery) shall be instituted. Work may proceed on other parts of the project site while mitigation measures for cultural resources is carried out.
- E. If significant materials are recovered, the qualified professional shall prepare a report on the findings for submittal to the Northwest Information Center.
- 8. Human Remains (Ongoing throughout demolition, grading, and/or construction). In the event that human skeletal remains are uncovered at the project site during ground-disturbing activities, all work shall immediately halt and the Alameda County Coroner shall be contacted to evaluate the remains, and following the procedures and protocols pursuant to CEQA Guidelines Section 15064.5 (e)(1). If the County Coroner determines that the remains are Native American, the City shall contact the California Native American Heritage Commission (NAHC), pursuant to Health and Safety Code Section 7050.5(c), and all excavation and site preparation activities shall cease within a 50-foot radius of the find until appropriate arrangements are made. If the agencies determine that avoidance is not feasible, then an alternative plan shall be prepared with specific steps and timeframe required to resume construction activities. Monitoring, data recovery, determination of significance and avoidance measures (if applicable) shall be completed expeditiously.
- 9. Paleontological Resources (Ongoing throughout demolition, grading, and/or construction). In the event of an unanticipated discovery of a paleontological resource during construction, excavations within 50 feet of the find shall be temporarily halted or diverted until the discovery is examined by a qualified paleontologist (per Society of Vertebrate Paleontology standards [SVP 1995,1996]). The qualified paleontologist shall document the discovery as needed, evaluate the potential resource, and assess the significance of the find. The paleontologist shall notify the appropriate agencies to determine procedures that would be followed before construction is allowed to resume at the location of the find. If the City determines that avoidance is not feasible, the paleontologist shall prepare an excavation plan for mitigating the effect of the project on the qualities that make the resource important, and such plan shall be implemented. The plan shall be submitted to the City for review and approval.

#### **ADDITIONAL CONDITIONS**

The following additional conditions are attached to this Permit:

- **10. Garage Height**. The garage shall have a maximum elevation of 490 feet, and the elevation point shall be noted in the plans.
- **11. Garage Trellis**. The trellis on the garage shall not be metal. The trellis material shall be noted in the plans.

- **12. Palm Trees**. All healthy palm trees shall be retained on site.
- **13. Historic Sign and Stairs at the Arlington Entrance**. The sign and stairs at the Arlington Avenue entrance to the property shall be restored. Photos showing the restored sign and stairs will be required before a Certificate of Occupancy is issued for new buildings.
- **14.** This Structural Alteration Permit is contingent upon Use Permit approval for the project.
- 15. Historic Preservation Treatment Plan. Prior to submittal of any building permit for this project, the applicant shall provide a site-specific historic preservation treatment plan for rehabilitation of the historic gymnasium building, main building terrace and concrete features throughout the site. The plan shall be prepared and implemented by or under the direct supervision of a Preservation Architect who meets or exceeds the Secretary of the Interior's Professional Qualifications Standards for Historic Architecture and Architectural History. This treatment plan shall define conditions assessment and documentation, protection, and monitoring requirements, and procedures to be implemented during restoration of the gymnasium, terrace, and concrete features, shall confirm structural conditions, and recommend preservation activities, protection measures, and procedures to be implemented. The building permit plan set shall demonstrate compliance with the treatment plan.
- **16. Rehabilitation of Historic Gymnasium**. Submittal of a building permit application to rehabilitate the gym is required prior to Landmarks plan check approval of any building permits for new buildings or structures.
- 17. Repair and replacement of character-defining features. Deteriorated historic features shall be repaired rather than replaced. Where the severity of deterioration requires replacement of a distinctive feature, the new feature shall match the old or historic feature in design, color, texture, and, where possible, materials. Replacement of missing features shall be substantiated by documentary and physical evidence.
- **18.** Chemical Treatments. With respect to historic resources located on this site or within the propose project area, any chemical treatments needed as construction progresses will be undertaken using the gentlest means possible.
- **19. Details and Materials.** Prior to Landmarks plan checker sign-off of the Building Permit set of drawings, the applicant shall submit building details, color and materials information for review and approval by Landmarks staff, in coordination with the LPC Chair as needed.

- **20.** All glass is assumed to be clear glass. Any proposed glass that is not clear glass, shall be indicated on all drawings, and shall be reviewed for approval by staff.
- **21.** All curbs and curb cuts shall be constructed per the standards and specifications of the Public Works Department. Curb cuts no longer utilized shall be restored per the Public Works Department specifications.
- **22.** Exterior lighting shall be downcast and not cause glare on the public right-of-way and abutting parcels.
- **23.** The applicant shall provide irrigation for all landscaped areas. This shall be called out on Landscape building permit drawings.
- 24. The applicant shall be responsible for identifying and securing all applicable permits from the Building and Safety Division and all other affected City divisions/departments prior to the start of work.

## GENERAL NOTES

## CONTRACTOR SHALL VERIFY ALL DIMENSIONS AND EXISTING BUILDING CONDITIONS IN THE FIELD PRIOR TO CONSTRUCTION. CONTRACTOR SHALL VERIFY ALL DIMENSIONS IN THE FIELD PRIOR TO STARTING WORK.

- 2. CONTRACTOR SHALL ADHERE TO ALL CODES, RULES AND REGULATION GOVERNING CONSTRUCTION, BUILDING ACCESS, AND THE USE OF FACILITIES AS SET BY FEDERAL, STATE, AND LOCAL CODES, AND BUILDING DEPARTMENT AGENCIES.
- 3. IT IS THE PURPOSE OF THE DRAWINGS TO SHOW THE GENERAL APRRANGEMENT/LAYOUT OF WALLS WITHIN THE PROPOSED STRUCTURE. ELEMENTS OF WORK THAT ARE TO BE CONSTRUCTED ON A DESIGN-BUILD BASIS SHALL BE APPROVED BY THE CITY/COUNTY BEFORE START OF CONSTRUCTION
- 4. LARGE SCALE DRAWINGS SHALL TAKE PRECEDENCE OVER SMALL SCALE DRAWINGS; DETAILS TAKE PRECEDENCE OVER ALL. CONTRACTOR SHALL NOTIFY ENGINEER OF CONFLICTS IN WRITING PRIOR TO COMMENCEMENT OF WORK, DRAWINGS ARE NOT TO BE SCALED FOR ANY REASON.
- ALL DIMENTIONS ARE TAKEN FRIM FACE OF STUD OR CENTERLINE OF STUD AS SHOWN FOR NEW CONSTRUCTION UNLESS OTHERWISE NOTED. DIMENSIONS SHALL BE TAKEN FROM FACE OF FINISH UNLESS OTHERWISE NOTED.
- 6. ALL WORK SHALL BE PERFORMED IN AN APPROVED WORKMANLIKE MANNER.
- 7. CONTRACTOR SHALL COORDINATE THE LOCATION OF THE LIGHTING, HVAC OUTLETS, ALONG WITH THE CEILINGS AND SOFFITTS BEFORE CONSTRUCTION BEGINS
- 8. CONTRACTOR SHALL COMPLY WITH CURRENT APPLICABLE LOCAL ORDINANCES FOR UTILITY SERVICES
- 9. CONTRACTOR SHALL OBTAIN AND PAY FOR ALL REQUIRED FEES, PERMITS. AND INSPECTION ASSESSED BY ANY GOVERNMENTAL AGENCY OR UTILITY COMPANY.
- 10. THE CONTRACTOR SHALL BE RESPONSIBLE FOR LOCATING ALL EXISTING UNDERGROUND UTILIES, WHERE ENCOUNTRERED, MAKE ALL NECESSARY ARRANGEMENTS FOR SUPPORT, SHORE-UP, RE-ROUTE OR PROVIDE UTILITY DISCONNECTIONS AS REQUIRED BY APPLICABLE PUBLIC OR PRIVATE UTILITY COMPANIES.
- 11. THE CONTRACTOR AND HIS SUBCONTRACTORS SHALL TAKE CAUTION WHEN WORKING AROUND THE EXISTING **UTILITIES AND UNDERGROUND LINES**
- 12. AT ALL TIMES, THE CONTRACTOR SHALL BE TOTALLY RESPONSIBLE FOR CONDITIONS OF THE SITE, INCLUDING THE SAFETY OF PERSONS AND PROPERTY; ALSO DESIGN ADEQUACY AND SAFETY OF ERECTION BRACING DURING SHORING, TEMPORARY, ETC. ENGINEER'S JOB SITE REVIEW OF THE ADEQUACY OF THE CONTRACTOR'S SAFETY **MEASURES**
- 13. THE CONTRACTOR SHALL WARRANT THAT ALL MATERIALS AND WORKMANSHIP ARE IN COMPLIANCE WITH DRAWINGS AND SPECIFICATIONS. ANY AND ALL CHANGES MUST HAVE THE ENGINEER'S APPROVAL.
- 14. THE CONTRACTOR SHALL BE RESPONSIBLE FOR COMPARING AND COORDINATING ALL DRAWINGS FOR PROPER FIT AND ATTACHMENT OF ALL PARTS. DETAILS NOT SHOWN, NOR DETAILED ON DRAWINGS, NOR CALLED FOR IN THESE NOTES SHALL BE CONSTRUCTED TO THE SAME SIZE AND CHARACTER AS FOR SIMILAR CONDITIONS WHICH ARE SHOWN. DETAILED, OR SPECIFIED.
- 15. THE CONTRACTOR SHALL COORDINATE WITH OWNER ALL NON ITEMS NOT SHOWN ON DRAWINGS.
- 16. THE CONTRACTOR SHALL COORDINATE ALL SUBCONTRACTORS UNDER HIS HIRE, AND SHALL COORDINATE WITH ANY SUBCONTRACTORS UNDER SEPARATE HIRE BY OWNER TO MAINTAIN EFFICIENT WORKMANLIKE PROGRESS OF THE WORK. THE CONTRACTOR SHALL COORDINATE THE OMITTED, BLOCKED OUT OR RELOCATED WITHOUT PRIOR APPROVAL WITH ENGINEER.
- 17. THE CONTRACTORS AND SUBCONTRACTORS OF EACH TRADE SHALL KEEP PREMISES CLEAN AT ALL TIME AND SHALL REMOVE ALL RUBBISH AS OFTEN AS REQUIRED (AT LEAST WEEKLY) FOR THE CONTRACTION AND FOR THE CONVENIENCE OF THE OWNER
- 18. PROTECTIVE MEASURES SHALL BE TAKEN BY THE CONTRACTOR TO PROTECT THE ADJACENT PROPERTY AT ALL TIMES DURING CONSTRUCTION. PROTECTIVE MEASURES SHALL BE TAKEN BY THE CONTRACTOR SO AS NOT TO CAUSE ANY MUD, SILT, OR DEBRIS ONTO PUBLIC OR ADJACENT PRIVATE PROPERTY.
- 19. CONTRACTOR SHALL BE RESPONSIBLE FOR DESIGN OF ALL TEMPORARY AND SHORING TO SUSTAIN ALL CONSTRUCTION LOADS, SOIL PRRESSURE, LATERAL, AND ANY OTHER LOADS THAT THE STRUCTURE MAY BE SUBJECTED.
- 20. ALL PARTITIONS SHALL BE BRACED TO ABOVE STUCTURE PER REQUIREMENTS OF LOCAL BUILDING CODE.
- 21. THE PROPOSED BUILDING SHALL BE CONNECTED TO THE STREET SEWER. SEE CIVIL PLANS FOR PROPOSED SANITARY SEWER PIPING AND CLEANOUTS.
- 22. A SEPARATE INSPECTION BY THE COUNTY BUILDING INSPECTOR IS REQUIRED TO DETERMINE THE DEPTH AND CLEANLINESS OF THE HOLES REQUIRED FOR EPOXY BOLTS BEFORE THEY ARE INSTALLED.

**BUILDING CODE** 

## PROJECT DATA

#### ADDRESS: 1960 SAN ANTONIO AVENUE BERKELEY CA 94707 62-2916-60-4 LOCAL JURISDICTION: **BERKELEY OCCUPANCY CLASS:** R3 **BASE ZONING:** R1-H

**VB NON SPRINKLERED** 

10 %

11.4 %

**CONSTRUCTION TYPE:** 

EXISTING PRIMARY BUILIDING FOOTPRINT	6572	SQ.FT.
TOTAL BUILDING FOOTPRINT	12969	SQ.FT.
BUILDING HEIGHT	30	FT.
BUILIDNG STORIES	2	
TOTAL LOT AREA	120873	SQ.FT.
NUMBER OF BUILDINGS ON LOT (EXISTING)	5	
NUMBER OF BUILDINGS ON LOT (PROPOSED)	6	
NUMBER OF PARCELS ON LOT (EXCLUDES	3	
PARCEL 4, 639 ARLINGTON, SHOWN ON SURVEY)		
NUMBER OF PARKING SPACES (EXISTING)	2	
NUMBER OF PARKING SPACES (PROPOSED)	10	

## **EXISTING LOT COVERAGE**

MAIN BUILDING	6540	SQ.FT.
COVERED PORCH 1	277	SQ.FT.
COVERED PORCH 2	519	SQ.FT.
GYM	2200	SQ.FT.
GAME ROOM/CAFETERIA	1868	SQ.FT.
GARAGE	443	SQ.FT.
SHED	235	SQ.FT.
TOTAL EXISTING AREA	12082	SQ.FT.

## PROPOSED LOT COVERAGE

EXISTING LOT COVERAGE

PROPOSED LOT COVERAGE

MAIN BUILDING	6540	SQ.FT.
COVERED PORCH 1	277	SQ.FT.
COVERED PORCH 2	519	SQ.FT.
GYM	2200	SQ.FT.
GAME ROOM	1321	SQ.FT.
GARAGE	2000	SQ.FT.
SHED	235	SQ.FT.
POOL HOUSE	641	SQ.FT.
TOTAL EXISTING AREA	13733	SQ.FT.
TOTAL LOT COVERAGE	12969	SQ.FT.

## SCOPE OF WORK

CALIFORNIA BUILDING CODE	2022	CALIFORNIA ENERGY CODE	2022	SCOPE OF WORK INVOLVES :
CALIFORNIA MECHANICAL CODE	2022	CALIFORNIA RESIDENTIAL CODE	2022	- CONSTRUCTION OF A NEW GARAGE, POOL, POOL
CALIFORNIA PLUMBING CODE	2022	CALIFORNIA GREEN BUILDING CODE	2022	POOL DECK, DRIVEWAY, AND LANDSCAPING - INTERIOR REMODEL OF MAIN BUILDING ON 1ST A
CALIFORNIA ELECTRICAL CODE	2022	CALIFORNIA FIRE CODE	2022	FLOORS UNDER A SEPERATE PERMIT - GLASS REPLACEMENT OF MAIN BUILDING WINDO
CITY OF BERKELEY MUNICIPAL CODE				FRAMES TO REMAIN.

# SPRING MANSION 1960 SAN ANTONIO AVENUE BERKELEY, CA 94707



## PROJECT DIRECTORY

#### OWNER: ABBAS MASH 1960 SAN ANTONIO AVENUE BERKELEY, CA 94707

**DESIGNER:** 

#### PAYMUN BUILDING AND DEVELOPMENT IN COLLABORATION WITH JONATHAN RACHMAN DESIGN 25 ORINDA WAY, SUITE 200 **ORINDA, CA 94563** TEL: 925-587-2140

#### ARCHITECT: PAYMUN BUILDING AND DEVELOPMENT IN COLLABORATION WITH 25 ORINDA WAY, SUITE 200 **ORINDA, CA 94563** TEL: 925-587-2140

#### LANDSCAPE ARCHITECT: DON WIHLBORG DESIGN 13 SEMINOLE AVE CORTE MADERA, CA 94925 TEL: 415 924 4466

#### STRUCTURAL ENGINEER: ADVANCED ENGINEERING 3381 WALNUT BLVD, SUITE 220 BRENTWOOD, CA 94513 TEL: 925 516 3502

GENERAL CONTRACTOR: PAYMAN BUILDING AND DEVELOPMENT 25 ORINDA WAY, SUITE 200 ORINDA, CA 94563 TEL: 925-587-2140

## SHEET INDEX

A010	PROJECT DATA
A020	GENERAL INFORMATION
L1	IRRIGATION PLAN
L2	IRRIGATION DETAIL
L3	IRRIGATION DETAILS & LEGEND
L4	PLANTING PLAN
L5	PLANTING DETAILS & LEGEND
L6	GRADING & DRAINAGE
A050	LOT COVERAGE - EXISTING & PROPOSED
A060	PHOTOS
A070	PHOTOS (MAIN HOUSE)
_A080_	PHOTOS (OUTDOOR)
A100 <sup>4</sup>	SITE PLAN - EXISTING
{ <b>A101</b> }	SITE PLAN - PROPOSED
A101B	ENLARGED SITE PLAN
A101C	SITE PLAN - SIMPLIFIED
A102	MAIN 1ST FLOOR PLAN - EXISTING & PROPOSED
A103	MAIN 2ND FLOOR PLAN - EXISTING & PROPOSED
A1044	MAIN ROOF PLAN - EXISTING & PROPOSED
A105	POOL HOUSE PLANS - PROPOSED
A105A	GARAGE PLANS - PROPOSED
A106	GYMNASIUM PLANS - EXISTING
A107	GAME ROOM PLANS & ELEVATIONS - EXISTING & PROPOSED
A108/4	CAFETERIA - DEMOLITION
A109	POOL EQUIPMENT ROOM PLAN, ELEVATION &
	SECTION
A201	MAIN ELEVATIONS WEST - EXISTING & PROPOSED
A202	MAIN ELEVATIONS EAST - EXISTING & PROPOSED
A203	MAIN ELEVATIONS NORTH & SOUTH - EXISTING
A204 <sup>4</sup>	POOL HOUSE ELEVATION - PROPOSED
A205	GARAGE ELEVATIONS - PROPOSED
A206	GYMNASIUM ELEVATIONS - EXISTING
A301	SITE SECTIONS
A302	SITE SECTIONS
A901 4	SHADOW STUDY

GARAGE AND POOL HOUSE RENDERING

# PAYMUN

25 Orinda way, Suite#200 Orinda, CA 94563 Tel: (925) 587-2140

Ben@paymun.com

#### LEAD DESIGN CONSULTANT

PAYMUN BUILDING & DEVELOPMENT, Inc.

DESIGNER & DRAFTER SADAF DAYLAMI

PROJECT

SPRING MANSION

OWNER(S)

ABBAS MASH

#### **NOTES** DATE REVISION

PLANNING SUBMITTAL I

LOCATION



**ADDRESS** 

1960 SAN ANTONIO AVENUE BERKELEY. CA 94707

**AREA** 

ORIENTATION

SHEET TITLE

PROJECT DATA

SCALE

AS INDICATED

SHEET NUMBER

## **ABBREVIATIONS**

&	AND	GALV.	GALVANIZED	REINF	REINFORCED
ANGLE	ANGLE	G.B.	GRAB BAR	REQ	REQUIRED
@	AT	GL.	GLASS	REV	REVISION
ငု	CENTERLINE	GND.	GROUND	RGTR	REGISTER
/	DIAMETER	GYP. BD.	GYPSUM BOARD	RM	ROOM
#	POUND OR NUMBER	H.B.	HOSE BIBB	RWD	REDWOOD
ABV.	ABOVE	H.C.	HOLLOW CORE	S	SOUTH
ACOUS.	ACOUSTICAL	H.M.	HOLLOW METAL	S.C.	SOLID CORE
A.D.	AREA DRAIN	H.R.	HAND RAIL	S.E.D	SEE ELECTRCIAL DWGS
A.T.	ACOUSTIC TILE	H.W.	HOT WATER	S.J	SEISMIC JOINT
ADJ.	ADJUSTABLE	HDR	HEADER	S.S.	STAINLESS STEEL
AGGR.	AGGREGATE	HR	HOUR	S.S.D	SEE STRUCTURAL DWGS
AL.	ALUMINUM	I.D.	INSIDE DIAMETER	SCHED	SCHEDULE
APPROX.	APPROXIMATE	INSUL	INSULATION	SECT	SECTION
ARCH.	ARCHITECTURAL	INT	INTERIOR	SHGT	SHEATHING
ASB.	ASBESTOS	JAN	JANITOR	SHT	SHEET
ASPH.	ASPHALT	KIT	KITCHEN	SIM	SIMILAR
BD.	BOARD	LAM	LAMINATE	SL	SKY LIGHT
BITUM	BITUMEN	LAV	LAVATORY	SPEC	SPECIFICATION
BLDG.	BUILDING	LBS	POUNDS	SPF	SPRAY FOAM INSULATION
BLK.	BLOCK	LTG	LIGHTING	SQ	SQUARE
ВМ	BEAM	M.D.F.	MEDIUM DENSITY FIBERBOARD	STD	STANDARD
BOT.	ВОТТОМ	MATL	MATERIAL	STL	STEEL
BSE.	BASE	MAX	MAXIMUM	STOR	STORAGE
CAB.	CABINET	MECH	MECHANICAL	STRUC	STRUCTURAL
C.B.	CATCH BASIN	MFR	MANUFACTURER	SUSP	SUSPENDED
CEM.	CEMENT	МН	MANHOLE	Т	TREAD
CER.	CERAMIC	MIN	MINIMUM	T.O.	TOP OF
C.I.	CAST IRON	MISC	MISCELLANEOUS	T.O.P.	TOP OF PLATE
C.B.	CORNER BOARD	MTD	MOUNTED	T.O.S.	TOP OF SLAB
CLG.	CEILING	MTL	METAL	T.O.W.	TOP OF WALL
CLKG.	CAULKING	MUL	MULLION	TEL	TELEPHONE
CLO.	CLOSET	N	NEW	TEMP	TEMPERED
CLR.	CLEAR	N	NORTH	THK	THICK
C.O.	CLEAN OUT	N.I.C.	NOT IN CONTRACT	TYP	TYPICAL
COL.	COLUMN	N.T.S.	NOT TO SCALE	UNF	UNFINISHED
EMER.	EMERGENCY	NO	NUMBER	UON	UNLESS OTHERWISE NOTED
ENCL.	ENCLOSURE	NOM	NOMINAL	UR	URINAL
E.P.	ELECTRIC PANELBOARD	O.C.	ON CENTER	V.C.T	VINYL COMPOSITION TILE
EQ.	EQUAL	O.D.	OUTSIDE DIAMETER	VAR	VARIES
EQUIP.	EQUOPMENT	OFF	OFFICE	W	WEST
E.W.P.	ELECTRIC WATER COOLER	OPER	OPERABLE	W.C.	WATER CLOSET
EXPO	EXPOSURE	OPNG	OPENING	W.G.	WATER GLASS
EXP.	EXPANSION	OPP	OPPOSITE	W.M.	WALL MOUNT
EXT.	EXTERIOR	P.LAM.	PLASTIC LAMINATE	W.O.	WHERE OCCURS
F.A.	FIRE ALARM	P.T.	PRESSURE TREATED	W.R.	WATER RESISTANT
F.B.	FLAT BAR	PAV	PAVING	W.W.F	WIRE WELDED FABRIC
F.D.	FLOOR DRAIN	PERF	PERFORATED	W.W.M	WOVEN WIRE MESH
FON.	FOUNDATION	PERP	PERPENDICULAR	W/D	WASHER / DRYER
F.E.	FIRE EXTINGUISHER	PL	PLATE	W/O	WITHOUT
F.E.C.	FIRE EXTINGUISHER CABINET	PL	PROPERTY LINE	WD	WOOD
F.H.C.	FIRE HOSE CABINET	PLYWD	PLYWOOD	WDW	WINDOW
FIN.	FINISH	PROP	PROPERTY	WP	WATERPROOFING
FL.	FLASHING	PT	PAINT	WT	WEIGHT
FLUOR.	FLUORESCENT	PVC	POLYVINYL CHLORIDE		
F.O.C.	FACE OF CABINET	QTY	QUANTITY		
F.O.F	FACE OF FINISH	R	RISER		
F.O.S.	FACE OF STUDS	R.C.	RESILIENT CHANNEL		
FPRF	FIREPROOF	R.C.P	REFLECTED CEILING PLAN		
F.S.	FULL SIZE	R.D.	ROOF DRAIN		
FT.	FOOT OR FEET	R.O.	ROUGH OPENING		
FTG.	FOOTING	R.W.L	RAIN WATER LEADER		
FURR.	FURRING	RAD	RADIUS		

**REFERENCE** 

REFRIGERATOR

**FUTURE** 

GAGE

## SYMBOLS

## DETAIL: Detail Number **Sheet Number** SECTION: Detail Number **Sheet Number** EXTERIOR/INTERIOR ELEVATION Sheet number Detail Number Name Elevation **ELEVATION HEIGHT**

DOOR TAG

WINDOW TAG

101

## WILDLAND-URBAN INTERFACE FIRE ZONE NOTES:

PRIOR TO BUILDING PERMIT FINAL APPROVAL, THE PROPERTY SHALL BE IN COMPLIANCE WITH THE VEGETATION MANAGEMENT REQUIREMENTS PRESCRIBED IN CALIFORNIA FIRE CODE SECTION 4906, INCLUDING CALIFORNIA PUBLIC RESOURCES CODE 4291 OR CALIFORNIA GOVERNMENT CODE SECTION 51182 PER CRC R337.1.5. BUILDING IS LOCATED IN AN LRA HIGH FIRE HAZARD SEVERITY ZONE. ALL EXTERIOR MATERIALS AND CONSTRUCTION METHODS SHALL MEET EXTERIOR WILDFIRE EXPOSURE STANDARDS.

WUI

## R337 WORKSHEET

THIS PROJECT IS LOCATED IN A LOCAL RESPONSIBILITY AREA VERY HIGH FOR WILDFIRE PROTECTION, ROOFING, ATTIC VENTILATION, EXTERIOR WALLS, WINDOWS, EXTERIOR DOORS, DECKING, FLOORS, AND UNDERFLOOR PROTECTION TO MEET CRC R337 REQUIREMENTS.

## ITEM

**DECKING MATERIALS EXTERIOR WINDOWS** EXTERIOR SIDINGS AND SHEATHINGS EXTERIOR DOORS

**UNDER EAVE UNDERFLOOR VENTILATION** ROOF

## **MATERIAL**


MASONRY OR CERAMIC MULTI-PANE GLAZING WITH ONE PANE TEMPERED 1" THICK STUCCO WITH 1 HOUR FIRE RATING MULTI-PANE GLAZING WITH ONE PANE TEMPERED WOOD GARAGE AND WOOD EXTERIOR DOORS TO BE MIN 1 3/8" THICK SOLD CORE **IGNITION RESISTANT IGNITION RESISTANT** 

CLOSED, NO VENTS CLASS A - MODIFIED BITUMIN, SLATE AT POOL HOUSE OR APPROVED EQUAL

## MAPS

# **AERAIL MAP** 1960 San Antonio Ave,

## **VICINITY MAP**

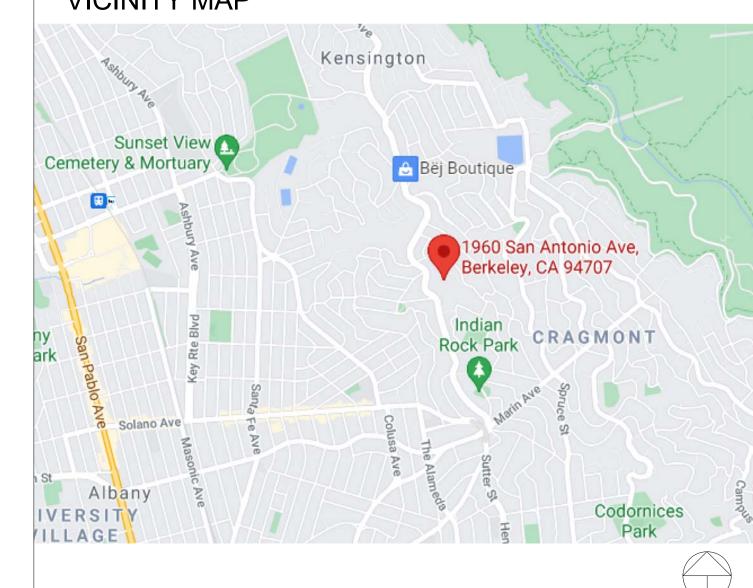

## TREE PROTECTION

- ANY ROOT PRUNING REQUIRED FOR CONSTRUCTION PURPOSES SHALL RECEIVE THE PRIOR APPROVAL OF AND BE SUPERVISED BY THE CONSULTING ARBORIST. ROOTS SHOULD BE CUT WITH A SAW TO PROVIDE A FLAT AND SMOOTH CUT. REMOVAL OF ROOTS LARGER THAN 2 IN. IN DIAMETER SHOULD BE AVOIDED.
- IF ROOTS 2 IN. AND GREATER IN DIAMETER ARE ENCOUNTERED DURING SITE WORK AND MUST BE CUT TO COMPLETE THE CONSTRUCTION, THE CONSULTING ARBORIST MUST BE CONSULTED TO EVALUATE EFFECTS ON THE HEALTH AND STABILITY OF THE TREE AND RECOMMEND TREATMENT.
- FENCE ALL TREES TO BE RETAINED TO COMPLETELY ENCLOSE THE TREE PROTECTION ZONE PRIOR TO DEMOLITION, GRUBBING OR GRADING. FENCES SHALL BE 6 FT. CHAIN LINK WITH POSTS SUNK INTO THE GROUND OR EQUIVALENT.
- THE TREE TREE PROTECTION ZONE SHOWN ON ALL PLANS SHALL BE FENCED TO ENCLOSE THE ENTIRE AREA (FIGURE 1). NO GRADING, EXCAVATION, CONSTRUCTION OR STORAGE OF MATERIALS SHALL OCCUR WITHIN THAT ZONE. NO UNDERGROUND SERVICES INCLUDING UTILITIES, SUB-DRAINS, WATER OR SEWER SHALL BE PLACED IN THE TREE PROTECTION ZONE. NO MOTORIZED EQUIPMENT SHALL BE USED IN THE TREE PROTECTION ZONE. THE LIMITS OF THE TREE PROTECTION ZONE WILL BE ADJUSTED FOLLOWING REVIEW OF GRADING AND CONSTRUCTION PLANS. FOR DESIGN PURPOSES, THE TREE PROTECTION ZONE

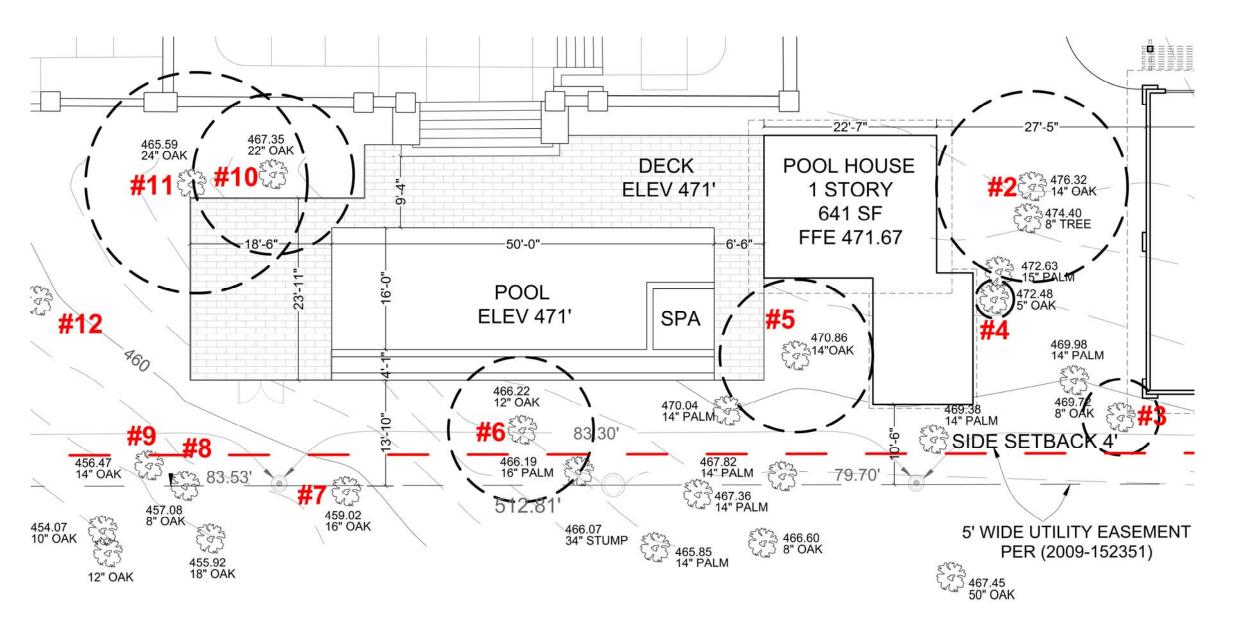


FIGURE 1. THE BLACK DOTTED LINES ARE THE TREE PROTECTION ZONE. WORK IN THIS AREA IS PROHIBITED.

# PAYMUN.

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DESIGNER & DRAFTER : SADAF DAYLAMI

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OWNER(S)

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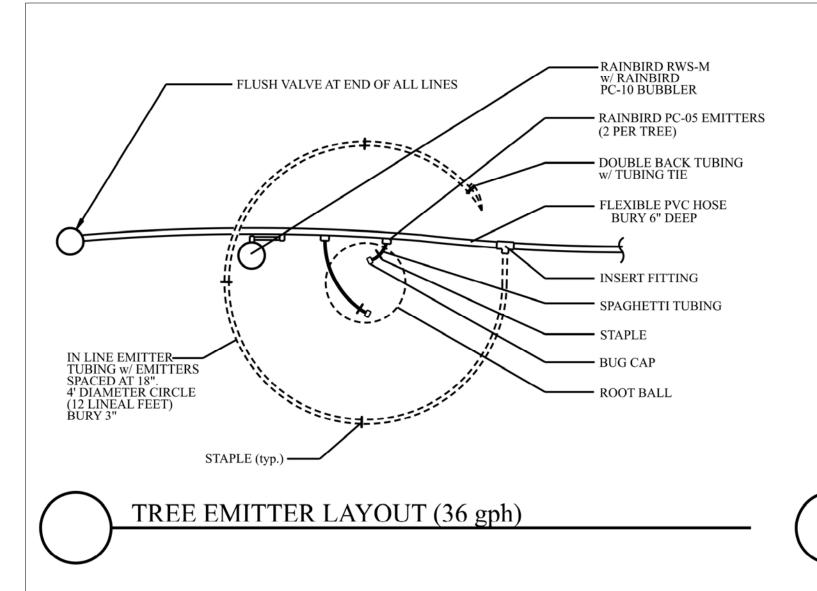
IRRIGATION PLAN

SCALE

AS INDICATED

SHEET NUMBER

L.1



6' Wide

Plant

TREE EMITTER LAYOUT - LARGE (33 gph)

5' Wide

MULTIPLE OUTLET EMITTER

Plant

— 1 GPH EMITTERS

BURY 6" DEEP

KBI UCV-0500-FF

— SPAGHETTI TUBING

CHECK VALVE

BUG CAP

- STAPLE (typ.)

@ 4' O.C.

DOUBLE BACK TUBING w/ TUBING TIE

(2 PER TREE)

RAINBIRD RWS-M w/ RAINBIRD

PCT-10 BUBBLER

FLUSH VALVE AT

END OF ALL LINES

IN LINE EMITTER -

4' DIAMETER CIRCLE

SPACED AT 18".

(12 LINEAL FEET) BURY 3"

IN LINE EMITTER

SPACED AT 18".


EMITTER HOSE -

TUBING w/ EMITTERS


MULTIPLE OUTLET EMITTER —

7' DIAMETER CIRCLE (22 LINEAL FEET) BURY 3"

TUBING w/ EMITTERS

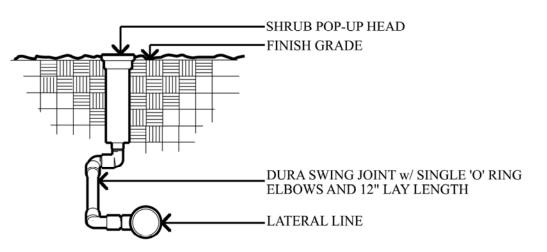

## 3/4" BRASS RISER 3/4" BRONZE COUPLING - 3/4" BRASS RISER ATTACH RISER TO 3/4" STAINLESS STEEL ROD AT TWO PLACES 6" (min.) SCH. 80 PVC NIPPLE MAIN LINE - BRONZE ELBOW USE EXTREME CAUTION WHEN DRIVING STAINLESS STEEL ROD. AVOID UTILITIES. REVIEW LOCATION w/ GENERAL CONTRACTOR BEFORE INSTALLATION.

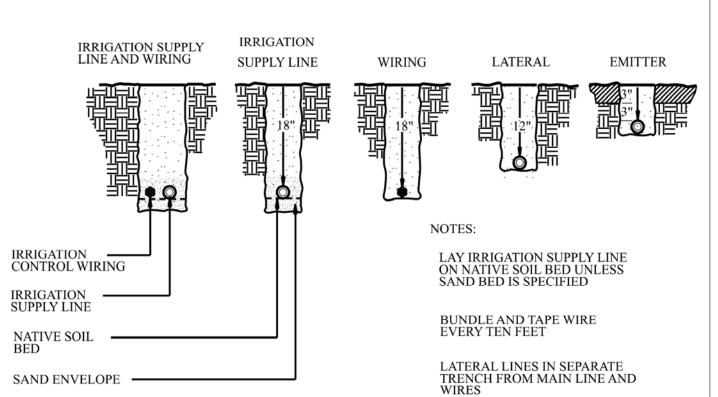

BACKFLOW

PREVENTER

— BALL VALVE

(when required)

— FINISH GRADE

6" CONCRETE PAD

UNION - one only

- PRESSURE REGULATOR

BRASS NIPPLE LENGTH AS REQUIRED (TYP.)

— SCHEDULE 80 TOE NIPPLE MIN. 12" LONG

SCHEDULE 80 COUPLING

— LINE FROM WATER METER

SAND ENVELOPE

FILTER —

MIN.

IRRIGATION

MAIN

## LEAD DESIGN CONSULTANT

PAYMUN

25 Orinda way, Suite#200

Orinda, CA 94563

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**PAYMUN BUILDING &** DEVELOPMENT, Inc.


DESIGNER & DRAFTER : SADAF DAYLAMI


PROJECT

SPRING MANSION

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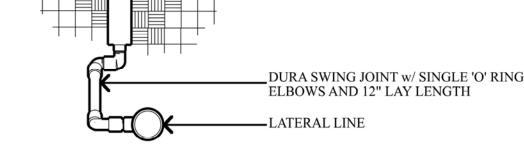
SHEET TITLE

IRRIGATION DETAILS

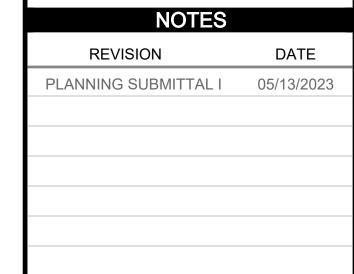SCALE

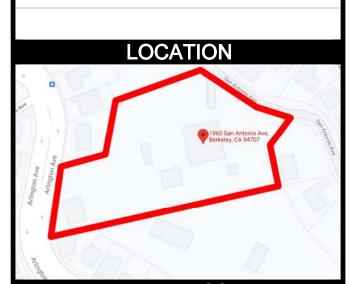**AS INDICATED** 


SHEET NUMBER




## SHRUB POP-UP SPRAY HEAD

AIR/VACUUM RELIEF

LINE FLUSHING VALVE

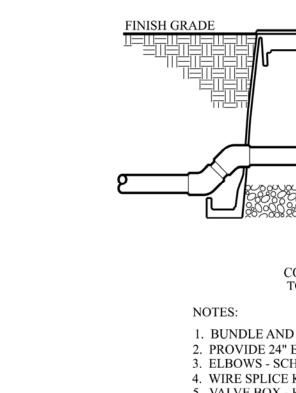

FINISH GRADE

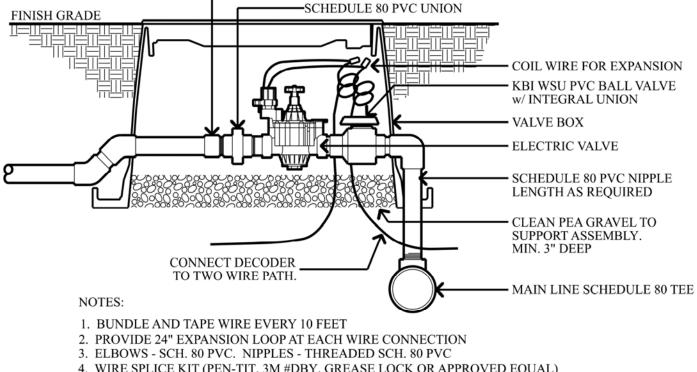

—SCHEDULE 80 MALE ADAPTER

4. WIRE SPLICE KIT (PEN-TIT, 3M #DBY, GREASE LOCK OR APPROVED EQUAL) 5. VALVE BOX - RAINBIRD VB-STD 6. PROVIDE AND INSTALL DECODER COMPATIBLE WITH CONTROLLER.


REMOTE CONTROL VALVE - TWO WIRE

PRESSURE REGULATING

BASKET FILTER

## REDUCED PRESSURE BACKFLOW PREVENTER


TRENCHING AND INSTALLATION

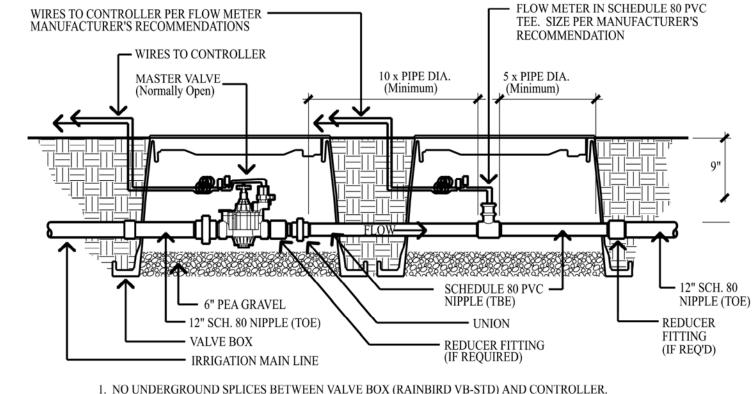



. NO UNDERGROUND SPLICES BETWEEN VALVE BOX (RAINBIRD VB-STD) AND CONTROLLER. 2. SPEARS # DS-100 w/ # DS-300 SEALANT OR 3M SCOTCHLOK # 3570 WIRE CONNECTORS ONLY INSTALL IN MANNER TO ALLOW PROPER DRAINAGE OF ANY WATER THAT ACCUMULATES IN VALVE BOX. FLOW METER SHOULD NEVER BE SUBMERGED UNDERWATER

MASTER VALVE & FLOWMETER RUN

## 6" ROUND -VALVE BOX GEOFLOW APVBK-1 AIR/VACUUM RELIEF . SCH. 80 NIPPLE -SCH. 80 NIPPLE -(LENGTH AS REQUIRED) (THREE) PEA GRAVEL SUMP PVC PIPING AND FITTING

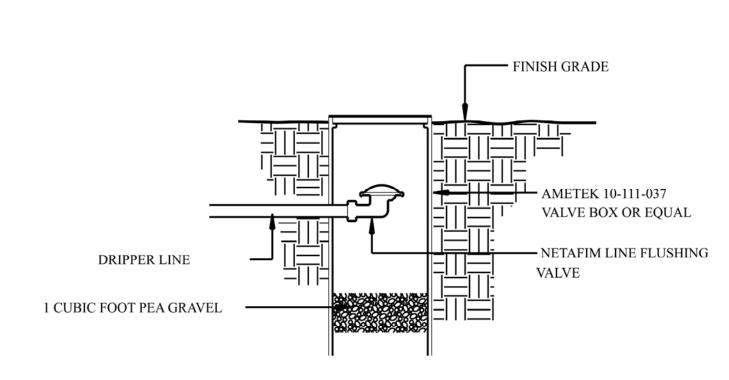

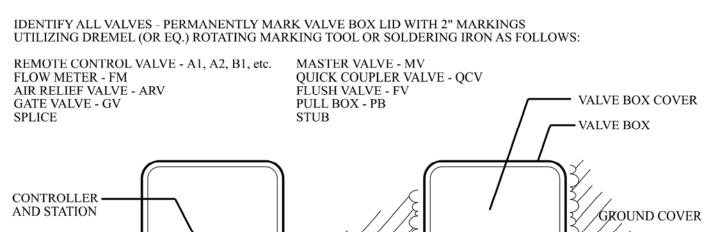

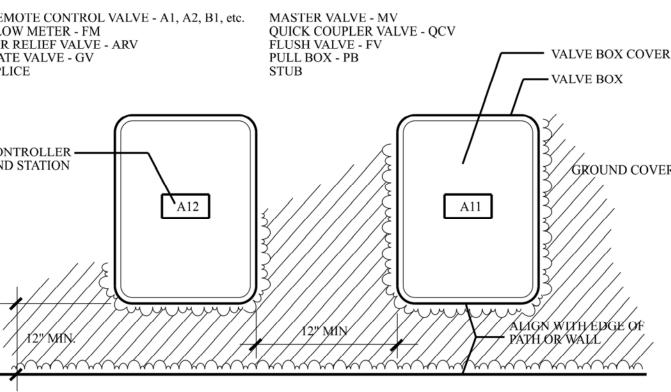

EMITTER LINE POP-UP OPERATION INDICATOR

# — FINISH GRADE DRIP EMITTER LINE - 1/4" DISTRIBUTION TUBING

RAINBIRD #OPERIND POP-UP OPERATION INDICATOR

— DISTRIBUTION TUBING CONNECTOR

- COIL WIRE FOR EXPANSION - KBI WSU PVC BALL VALVE w/ INTEGRAL UNION - VALVE BOX — ELECTRIC VALVE - SCHEDULE 80 PVC NIPPLE LENGTH AS REQUIRED - CLEAN PEA GRAVEL TO SUPPORT ASSEMBLY. MIN. 3" DEEP CONNECT DECODER TO TWO WIRE PATH. - MAIN LINE SCHEDULE 80 TEE NOTES: 1. BUNDLE AND TAPE WIRE EVERY 10 FEET 2. PROVIDE 24" EXPANSION LOOP AT EACH WIRE CONNECTION 3. ELBOWS - SCH. 80 PVC. NIPPLES - THREADED SCH. 80 PVC 4. WIRE SPLICE KIT (PEN-TIT, 3M #DBY, GREASE LOCK OR APPROVED EQUAL) 5. VALVE BOX - RAINBIRD VB-STD 6. PROVIDE AND INSTALL DECODER COMPATIBLE WITH CONTROLLER

EMITTER REMOTE CONTROL VALVE - TWO WIRE


**VALVE BOXES** 

— ELECTRICAL POWER CONDUIT ELECTRICAL PULL BOX

— CONTROLLER

— CONTROL WIRE CONDUIT

WALL MOUNT CONTROLLER

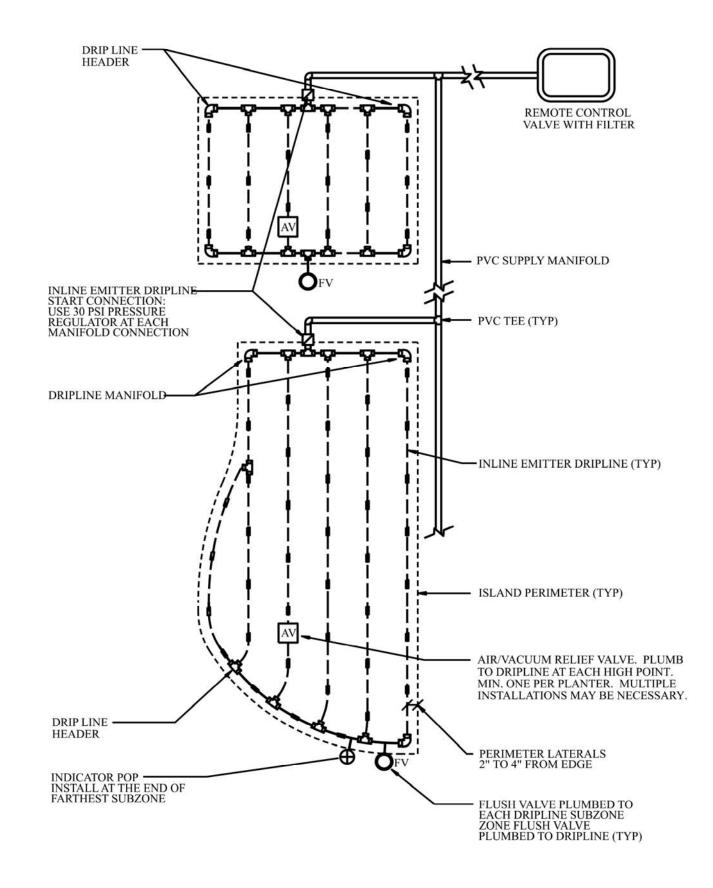

INLINE EMITTER ISLAND LAYOUT

IRRIGATION LEGEND

Existing Pressure

	Description	MANUFACTURER	Item Number	Pop Height	Misc. Info.	GPM	at PSI	Radius
	Shrub Rotator	Hunter	PROS-12-PRS40-CV-MP1000	12"		0.19-0.75	40	14
	Shrub Rotator	Hunter	PROS-12-PRS40-CV-MP2000	12"		0.40-1.47	40	19
	Shrub Rotator	Hunter	PROS-12-PRS40-CV-MP3000	12"		0.86-3.64	40	30
•	Tree Emitter Layout		See details					
<b>(©)</b>	Tree Emitter Layout Large		See details					
	Root Watering System	Rainbird	RWS (see tree emitter detail)		18", PCT-10 Emitter			
	Multi Outlet Emitter	Rainbird	XBT-20-6		2.0 GPH per Emitter Outlet			
	Emitter	Rainbird	PC-10			10 gph		
	Controller	Hunter	HC - 2 wire		w/ Solar-Sync, connect to Wi-Fi			
$\triangle$	Flow Sensor	CST	FDI-T10-001		1" Flow Meter	0.86-52		
	Backflow Preventer	Wilkins	975XL2U		1"			
(F)	Filter	Amiad	Super 1"					
•	Control Valve	Rainbird	PESB-PRS-D Series					
•	Control Zone Kit	Rainbird	XZC-150-PRB-COM		Zones over 15 gpm			
•	Control Zone Kit	Rainbird	XCZ-100-PRB-COM		Zones between 5 and 15 gpm.			
•	Control Zone Kit	Rainbird	XCZ-75-PRF		Zones under 5 gpm			
$\oplus$	Master Valve	Griswold	2000 Series		Normally Open, line size			
•	Hose Bib							
	Emitter Flush Valve	Netafim			Automatic Flush			
	Emitter Air Relief Valve	Netafim			At all high points of emitter zones			
	Emitter Pop-up Indicator	Rainbird	OPERIND		One at end of each zone			
	Main Line Pipe		Schedule 40					
	Lateral Line Pipe		Schedule 40					
	Emitter Line Pipe		AR Flexible PVC		1"			
	In Line Emitter Tubing	Rainbird	XFS-09-18 Sub-Surface Dripline w/ copper shield		18" pipe spacing	0.9 GPH		
	Drip Line Header	Rainbird	XQF-10 Dripline Header					
=======================================	Sleeve		Schedule 40		w/ size			
	Buried Pipe w/o Sleeve		Copper					

Maximum Applied Water Allowance (MAWA) (Eto)(0.62))(0.55 x LA(Landscape Area)(+(0.45 x SLA(Special Landscape Area)() = 215,883 39.0 0.62 Eto = Factor = LA -16,233

Estimated Total Water Use (ETWU)
(E53(0.62)(PFxHA/II)+S(A)+ 210,355

Hydrocone Type	Volve Number	Irrigatio n Method	Water Use Type	Hydrozone Area (HA)	Percent of Landscape	Plant Factor (PF)	Special Landscape Area (SLA)	Irrigation Efficiency (IE)	PF x HA	ETWU	MAWA	Over/ Under MAWA	Application Rate In./Hr.	Operating Pressure PSI
Shrubs	1	drip:	Low	122	0.8%	0.3	0	0.80	37	1,106	3,622	516	1.5	30
Shrubs	2	drip	Low	146	0.9%	0.3	0	0.80	-44	1,324	1.942	618	1.76	30
Shrubi	3	MF Rotor	Low	828	5.1%	0.3	0	0.75	248	8,008	11,012	3,003	1.5	40
Shrubs	4	MP Rotor	Low	993	6.3%	0.3	0	0.75	298	9,604	13;206	3,602	1.5	-40
Shrubt	5	MP Rotor	Low	1,292	8.0%	0.3	0	0.75	333	12,496	17,182	4,686	1.5	-60
Low Water Grass	6	MF Rotor	Low	952	5.5%	0.3	0	0.75	285	9,208	12,661	3,453	1.5	40
Shrubs	7	MP Rotor	Low	181	5.1%	0.3	0	0.75	54	1,751	2,407	656	1.5	40
Shrubs	8	MP Rotor	Low	985	6.1%	0.3	0	0.75	296	9,527	13,100	3,578	1.5	40
Shrubs	9	drip	Mod	35	0.2%	0.5	0	0.80	35	529	465	63	1.76	30
Shrubs	30	drip	Low	408	2.5%	0.3	0	0.80	122	3,700	5,426	1,726	1.5	30
Shorts	11	drip.	Low	355	2.2%	0.3	0	0.80	107	3,219	4,721	1,502	1.5	30
Shrubs	12	drip	Low	-84G	2.7%	0.3	0	0.80	134	4,044	5,931	1,687	0.45	30
Trees	23	drip	Low	176	2.1%	0.3	0	0.80	53	1,556	2,341	745	1.5	30
Shruhi	54	drip	Low	123	0.8%	0.3	0	0.80	37	1,115	1,636	520	1.5	30
Shoot	45	drip	Low	668	4.1%	0.3	0	0.80	200	6,057	3,584	2,827	0.45	30
Shrubi	16:	drip	Low	597	1.7%	0.3	0	0.80	179	5,413	7,940	2,526	0.45	30
Shrubi	17.	drip.	Lone	59	0.4%	0.3	0	0.80	18	535	785	250	1.76	30
Swass	18	drip	Low	318	1.9%	0.3	0	0.80	94	2,838	4,163	1,324	0.45	30
Low Water Grass	19	MP Rotor	Low	356	2.2%	0.3	0	0.75	107	3,443	4,734	1,291	1.5	40
Shrubi	20	MP Rotor	Mod	812	5.0%	0.5	0	0.75	406	13,089	10,799	2,791	0.45	40
Shrubs	21	spray	Mod	109	0.7%	0.5	0	0.75	55	1,757	1,450	307	1.76	30
Shoules	55	drip	Med	252	3.6%	0.6	0	0.80	151	4,570	3,351	1,219	1.5	30
Shrubt	2.1	drip	Mod	502	3.1%	0.6	0	0.80	301	9,104	6,676	2,426	1.5	30
Tobes	24	drip	Low	112	0.7%	0.3	0	0.80	34	1,016	1,489	474	1.76	30
Swits	25	Spray	Low	174	2.1%	0.3	0	0.75	52	1,683	2.314	631	1.76	30
Shrubs	26	drip	Mod	499	3.1%	0.6	0	0.90	299	9,049	6,636	2,413	1.76	30
Shrubi	27	drip	Mod	122	0.876	0.5	0	0.50	62	1,844	1.632	221	1.76	30
Trees	28	drip	Low	144	0.9%	0.3	0	0.80	43	1,306	1.915	609	1.5	30
Shoubs	29	drip:	Med	323	2.0%	0.6	0	0.80	194	5,858	4,296	1,562	1.76	30
Shrubi	30	drip	Mod	174	1.1%	0.6	0	0.90	104	3,155	2,314	841	1.5	30
Shrubi	31	drip	Mod	179	2.1%	9.6	0	0.80	107	3,246	2,381	866	1.5	30
Smits	32	drip	Med	212	1.3%	0.6	0	0.80	127	3,845	2,819	1,025	1.5	30
Shrubs	33	MP Rotor	Mod	780	4.8%	0.6	0	0.75	468	15,088	10,373	4,715	1.5	40
Shrubs	34	spray	Mod	506	3.1%	0.6	0	0.75	334	9,788	6,729	3,059	1.76	30
Shrubs	35	MP Rotor	Med	782	4.8%	0.6	0	0.75	469	15,127	10,400	4,727	0.45	40
Shrubs	36	drip.	Mod	375	2.8%	0.6	0	0.80	225	6,801	4,987	1,814	1.5	30
Shrubi	37	drip	Mod	126	0.8%	0.6	0	0.90	75	2,285	1,676	609	1.5	30
Topes	35	drip	Low	176	2.1%	0.3	0	0.80	-53	1,596	2,341	745	0.45	30
Small	33	drip	Med	420	2,6%	0.6	0	0.80	252	7,617	5,586	2,031	0.45	30
Shrubs	40	drip	Mod	117	0.7%	0.6	0	0.80	70	2,122	3,556	566	1.5	30
Shrubi	41	drip	Mod	164	1.0%	0.6	0	0.00	95	2,974	2,151	793	1.5	30
Trees	42	drip	Low	64	0.4%	0.3	0	0.83	13	580	851	271	1.5	30
Shoot	43	drip.	Mod	74	0.5%	0.6	0	0.80	44	1.342	984	358	1.5	30

No and Low water area = 59.6% PAYMUN

25 Orinda way, Suite#200 Orinda, CA 94563 Tel: (925) 587-2140

Ben@paymun.com

LEAD DESIGN CONSULTANT

PAYMUN BUILDING & DEVELOPMENT, Inc.

> DESIGNER & DRAFTER : SADAF DAYLAMI

**PROJECT** 

**SPRING MANSION** 

OWNER(S)

ABBAS MASH

NOTES DATE REVISION PLANNING SUBMITTAL I 05/13/2023

LOCATION



**ADDRESS** 

1960 SAN ANTONIO AVENUE BERKELEY, CA 94707

AREA

ORIENTATION


SHEET TITLE

IRRIGATION **DETAILS & LEGEND** 

SCALE

AS INDICATED

SHEET NUMBER

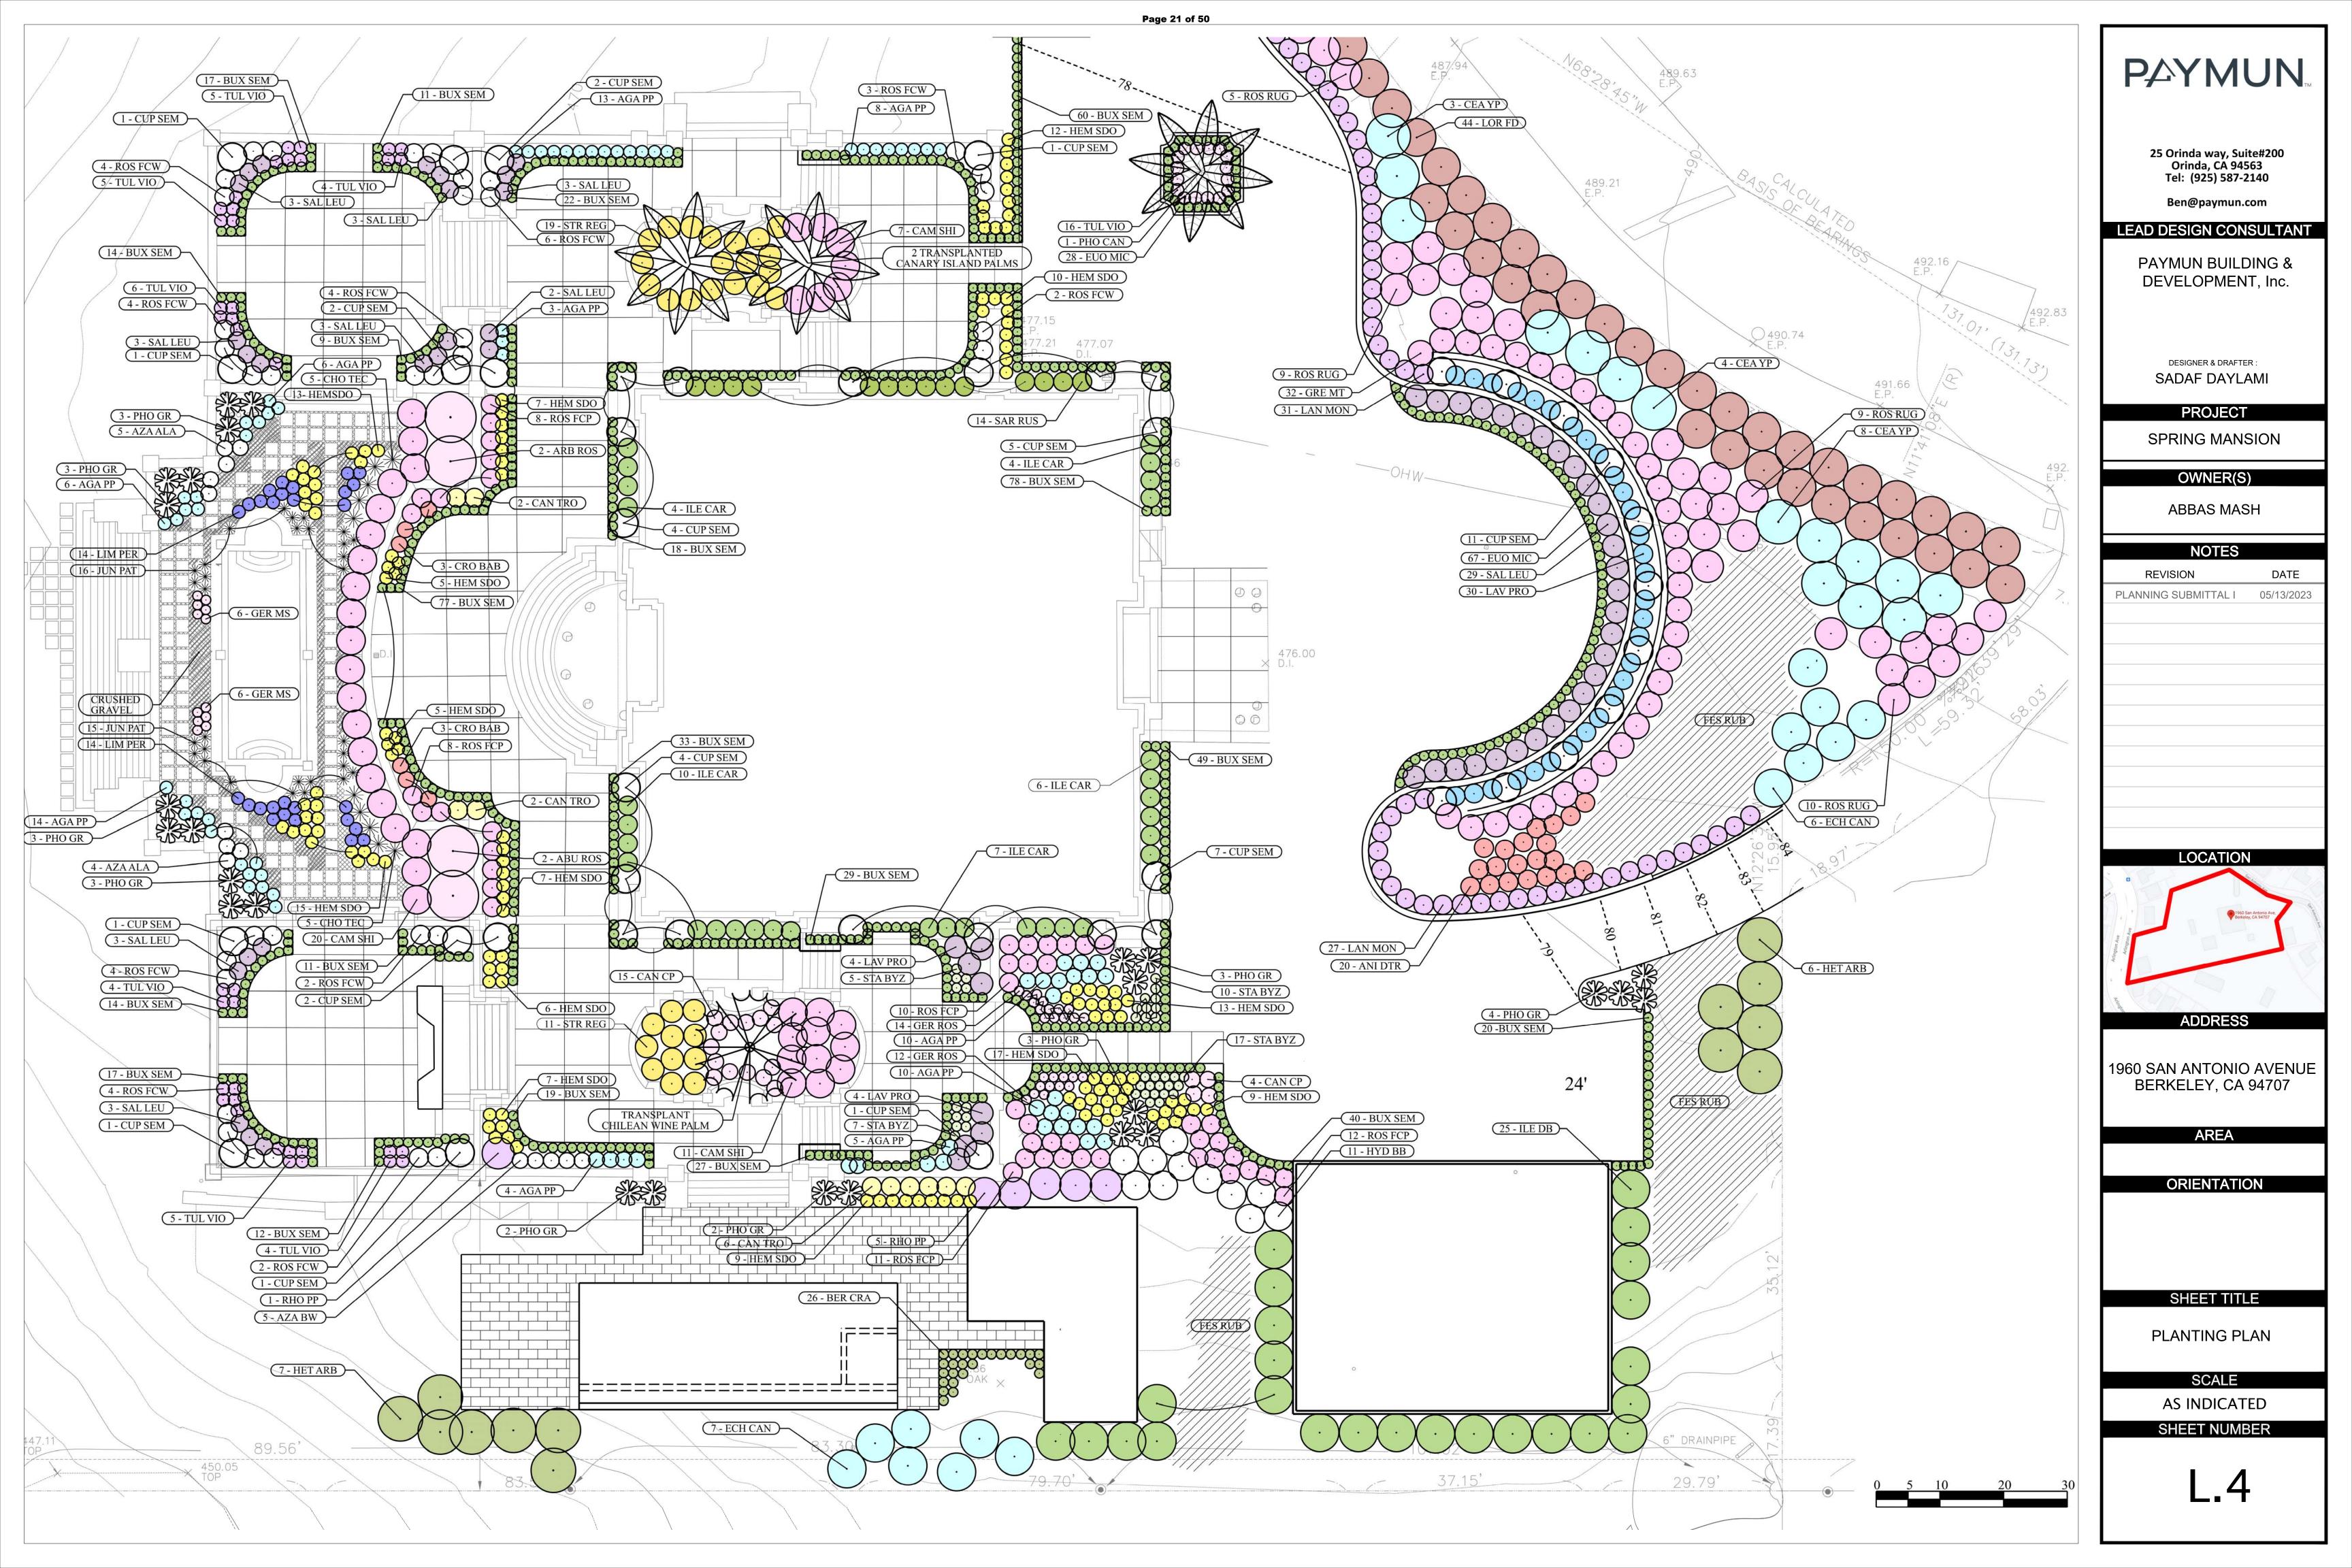

#### PLANTING NOTES

1. LANDSCAPING CONTRACT TO INCLUDE, BUT NOT NECESSARILY BE LIMITED TO:

PROVISION AND INSTALLATION OF SOIL AMENDMENT PLANTING OF TREES, SHRUBS, AND GROUND COVERS

\_\_FERTILIZING \_\_\_MULCHING

IRRIGATION IRRIGATION PREPARATION OF SUBSOIL

2. DURING AMENDMENT PROCEDURES OR PLACING OF TOPSOIL, REMOVE: STONES ROOTS GRASS WEEDS DEBRIS

FOREIGN MATERIAL DELETERIOUS TO PLANT GROWTH

3. PLANTING BEDS:

ROTILL AMENDMENT INTO SOIL 12" DEEP PRIOR TO PLANTING

TILL AMENDMENT BY HAND 6" DEEP UNDER DRIPLINE OF EXISTING TREES CONTRACT WITH ENVIROMENTAL TECHNICAL SERVICES FOR SOILS REPORT. AMEND WITH MATERIALS RECOMMENDED IN REPORT. MIN. 10 CY ORGANIC MATERIAL/1000 SF.

4. PLANT MATERIALS:

FREE OF DISEASE OF HAZARDOUS INSECTS

PLACE AGRI-FORM PLANT TABS IN PLANT PITS AT THE FOLLOWING RATES:

1 GALLON PLANT - 1 TABLET

5 GALLON PLANT - 2 TABLETS

15 GALLON PLANT - 3 TABLETS 24" BOX - 4 TABLETS

GIVE 48 HOUR NOTICE TO THE LANDSCAPE ARCHITECT PRIOR TO DELIVERY TO THE

SITE OF ALL PLANT MATERIALS \_\_PLACE ON SITE IN THE LOCATIONS SHOWN FOR REVIEW BY THE LANDSCAPE ARCHITECT BEFORE ANY PLANTING HOLES ARE DUG

5. MULCH ALL AREAS OF NEW PLANTING 3" DEEP WITH BARK. PROVIDE SAMPLE FOR APPROVAL.

6. REMOVE AND REPLACE ANY TREE DAMAGED BEYOND REPAIR WITH A TREE OF SIMILAR CHARACTER AND SIZE AS SPECIFIED BY THE OWNER, AT THE CONTRACTOR'S EXPENSE

7. GIVE 48 HOUR NOTICE TO LANDSCAPE ARCHITECT PRIOR TO FINAL INSPECTION OF ALL

PLANT MATERIALS.

8. WARRANTY PERIOD: ONE YEAR FOR PLANTING AND IRRIGATION

....COMMENCE ON DATE OF ACCEPTANCE OF PLANTING AFTER FINAL INSPECTION.

9. SCHEDULE PRECONSTRUCTION CONFERENCE WITH LANDSCAPE ARCHITECT. DO NOT BEGIN CONSTRUCTION BEFORE CONFERENCE. IF CONSTRUCTION BEGINS BEFORE CONFERENCE, CONTRACTOR MAY BE ASKED BY LANDSCAPE ARCHITECT TO UNDO SOME OF THE WORK AT NO ADDITIONAL COST TO THE OWNER.


10. AREA UNDER DRIP LINE OF EXISTING ON-SITE AND OFF-SITE TREES:


FENCE ENTIRE DRIPLINE DO NOT STOCKPILE MATERIALS

NO VEHICULAR TRAFFIC

DO NOT CUT ROOTS LARGER THAN 2" DIAMETER


Abbrev.	Botanical Name	Common Name	Size	Comments	Height	Spread	Water
ABU ROS	ABUTILON h.'Roseus'	Pink Flowering Maple	5 gal		9.00	9.00	$\overline{}$
AGA PP	AGAPANTHUS 'Peter Pan'	Peter Pan Agapanthus	1 gal		1.50	2.25	M
ANI BP	ANIGOZANTHOS 'Bush Pearl'	Bush Pearl Kangaroo Paw	1 gal		1.50	1.50	
ANI DTR	ANIGOZANTHOS 'Dwarf Tall Red'	Dwarf Tall Red Kangaroo Paw	5 gal		3.00	3.00	L
AZAALA	AZALEA 'Alaska'	Alaska Azalea	5 gal		2.50	3.00	M
AZA BW	AZALEA 'Bloomathon White'	Bloomathon White Azalea	5 gal		2.50	2.50	M
BER CRA	BERGENIA crassifolia	Heartleaf Bergenia	1 gal		1.25	1.25	L
BUX SEM	BUXUS sempervirens 'Suffruticosa'	Boxwood BALLS	15 gal		2.00	2.00	_
CAM SHI	CAMELLIA h. 'Shishi-Gashira'	Shishi-Gashira Camellia	15 gal		3.00	6.00	
CAN CP	CANNA 'China Pink'	China Pink Canna	5 gal		3.00	2.50	M
CAN TRO	CANNA 'Tropicanna'	Tropicanna Canna	1 gal		5.00	3.00	_
CEA YP	CEANOTHUS griseus horizontalis 'Yankee Point'	Yankee Point Ceanothus	5 gal		2.50	7.00	_
CHO TEC	CHONDROPETALUM tectorum	Small Cape Rush	5 gal		3.00	4.00	_
CRO BAB	CROCOSMIA 'Babylon'	Babylon Crocosmia	1 gal		2.50	1.50	_
CUP SEM	CUPRESSUS sempervirens 'Stricta'	Italian Cypress		field grown; 3' dia foliage	tree		L
ECH CAN	ECHIUM candicans	Pride of Madeira	5 gal		5.00	6.00	L
EUO MIC	EUONYMUS japonicus 'Microphyllus'	Box-Leaf Euonymus	1 gal		1.50	1.50	_
ES RUB	FESTUCA rubra	Red Fescue	sod		0.00		L
GER MS	GERANIUM r. 'Mavis Simpson'	Mavis Simpson Geranium	1 gal		1.00	1.00	M
GRE MT	GREVILLEA lanigera 'Mt. Tamboritha'	Mt. Tambor Grevillea	1 gal		2.00	4.00	_
HEM SDO	HEMEROCALLIS 'Stella De Oro'	Stella De Oro Daylily	1 gal		2.00	2.00	
HET ARB	HETEROMELES arbutifolia	Toyon	5 gal		7.00	7.00	_
HYD BB	HYDRANGEA m. 'Blushing Bride'	Blushing Bride Hydrangea	5 gal		4.00	4.00	_
LE CAR	ILEX cornuta 'Carissa'	Carissa Chinese Holly	5 gal		3.50	5.00	_
LE DB	ILEX cornuta 'Dwarf Burford'	Dwarf Burford Holly	5 gal		6.00	6.00	_
UN PAT	JUNCUS patens 'Elk Blue'	Elk Blue California Gray Rush	1 gal		2.00	2.00	_
LAN MON	LANTANA montevidensis	Trailing Lantana	5 gal		1.50	3.00	
LAV PRO	LAVANDULA i. 'Provence'	Provence Lavender	1 gal		2.00	3.00	_
IM PER	LIMONIUM perezii	Statice, Sea Lavendar	1 gal		2.00	2.00	_
OR FD	LOROPETALUM chinense 'Flame Dance'	Flame Dance Loropetalum	5 gal		6.00	6.00	_
HO GR	PHORMIUM 'Golden Ray'	Golden Ray Flax	5 gal		4.00	4.00	_
RHO PP	RHODODENDRON 'Purple Passion'	Purple Passion Rhododendron	5 gal		6.00	5.00	
ROS FCP	ROSA 'Flower Carpet Pink'	Flower Carpet Pink Rose	5 gal		2.00		M
ROS FCW	ROSA 'Flower Carpet White'	Flower Carpet White Rose	5 gal		2.00		M
OS RUG	ROSA rugosa	Ramanas Rose	5 gal		3.50	5.00	-
ALLEU	SALVIA leucantha	Mexican Bush Sage	5 gal		3.50	4.00	_
AR RUS	SARCOCOCCA rusifolia	Fragrant Sarcococca	5 gal		4.00	3.00	
TA BYZ	STACHYS byzantina	Lamb's Ear	1 gal		1.50	1.50	_
STR REG	STRELITZIA reginae	Bird of Paradise	5 gal		4.00	4.00	_
TUL VIO	TULBAGHIA violacea	Society Garlic	1 gal	†	1.50	2.50	_

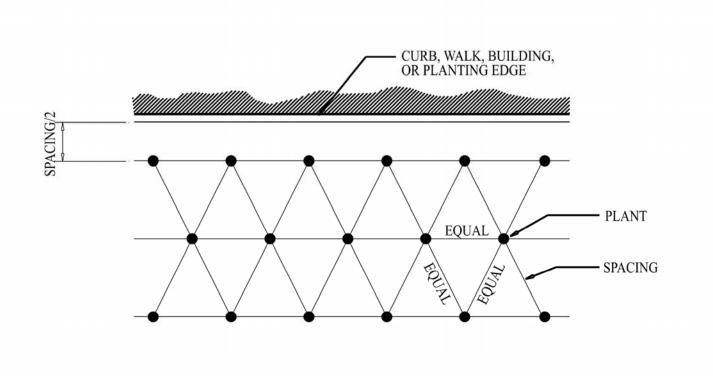


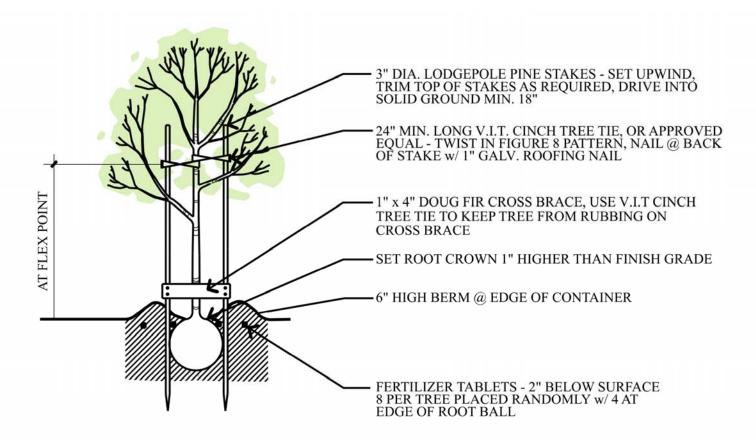

GROUND COVER PLANTING

TREE PLANTING

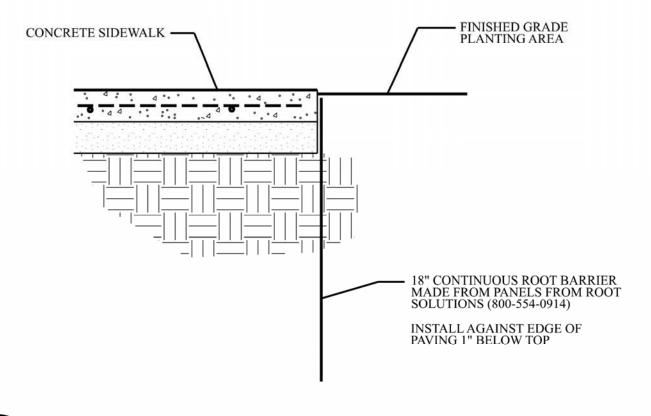

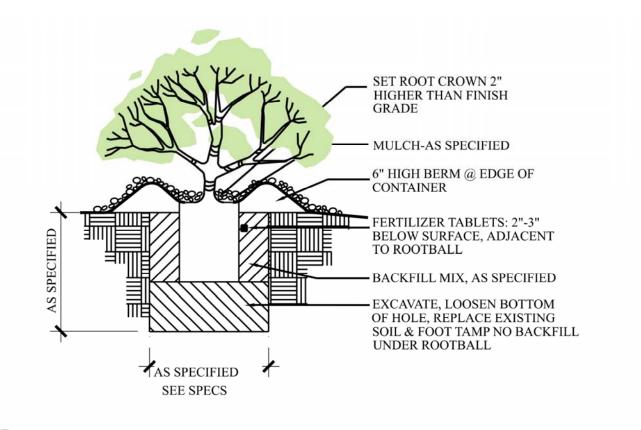

ROOT BARRIER ALONG PAVING

SHRUB PLANTING

25 Orinda way, Suite#200 Orinda, CA 94563 Tel: (925) 587-2140

Ben@paymun.com

#### LEAD DESIGN CONSULTANT

PAYMUN BUILDING & DEVELOPMENT, Inc.

> DESIGNER & DRAFTER: SADAF DAYLAMI

PROJECT

**SPRING MANSION** 

OWNER(S)

ABBAS MASH

NOTES

REVISION	DATE
PLANNING SUBMITTAL I	05/13/2023



**ADDRESS** 

1960 SAN ANTONIO AVENUE BERKELEY, CA 94707

**AREA** 

ORIENTATION


SHEET TITLE

PLANTING **DETAILS & LEGEND** 

SCALE

AS INDICATED

SHEET NUMBER

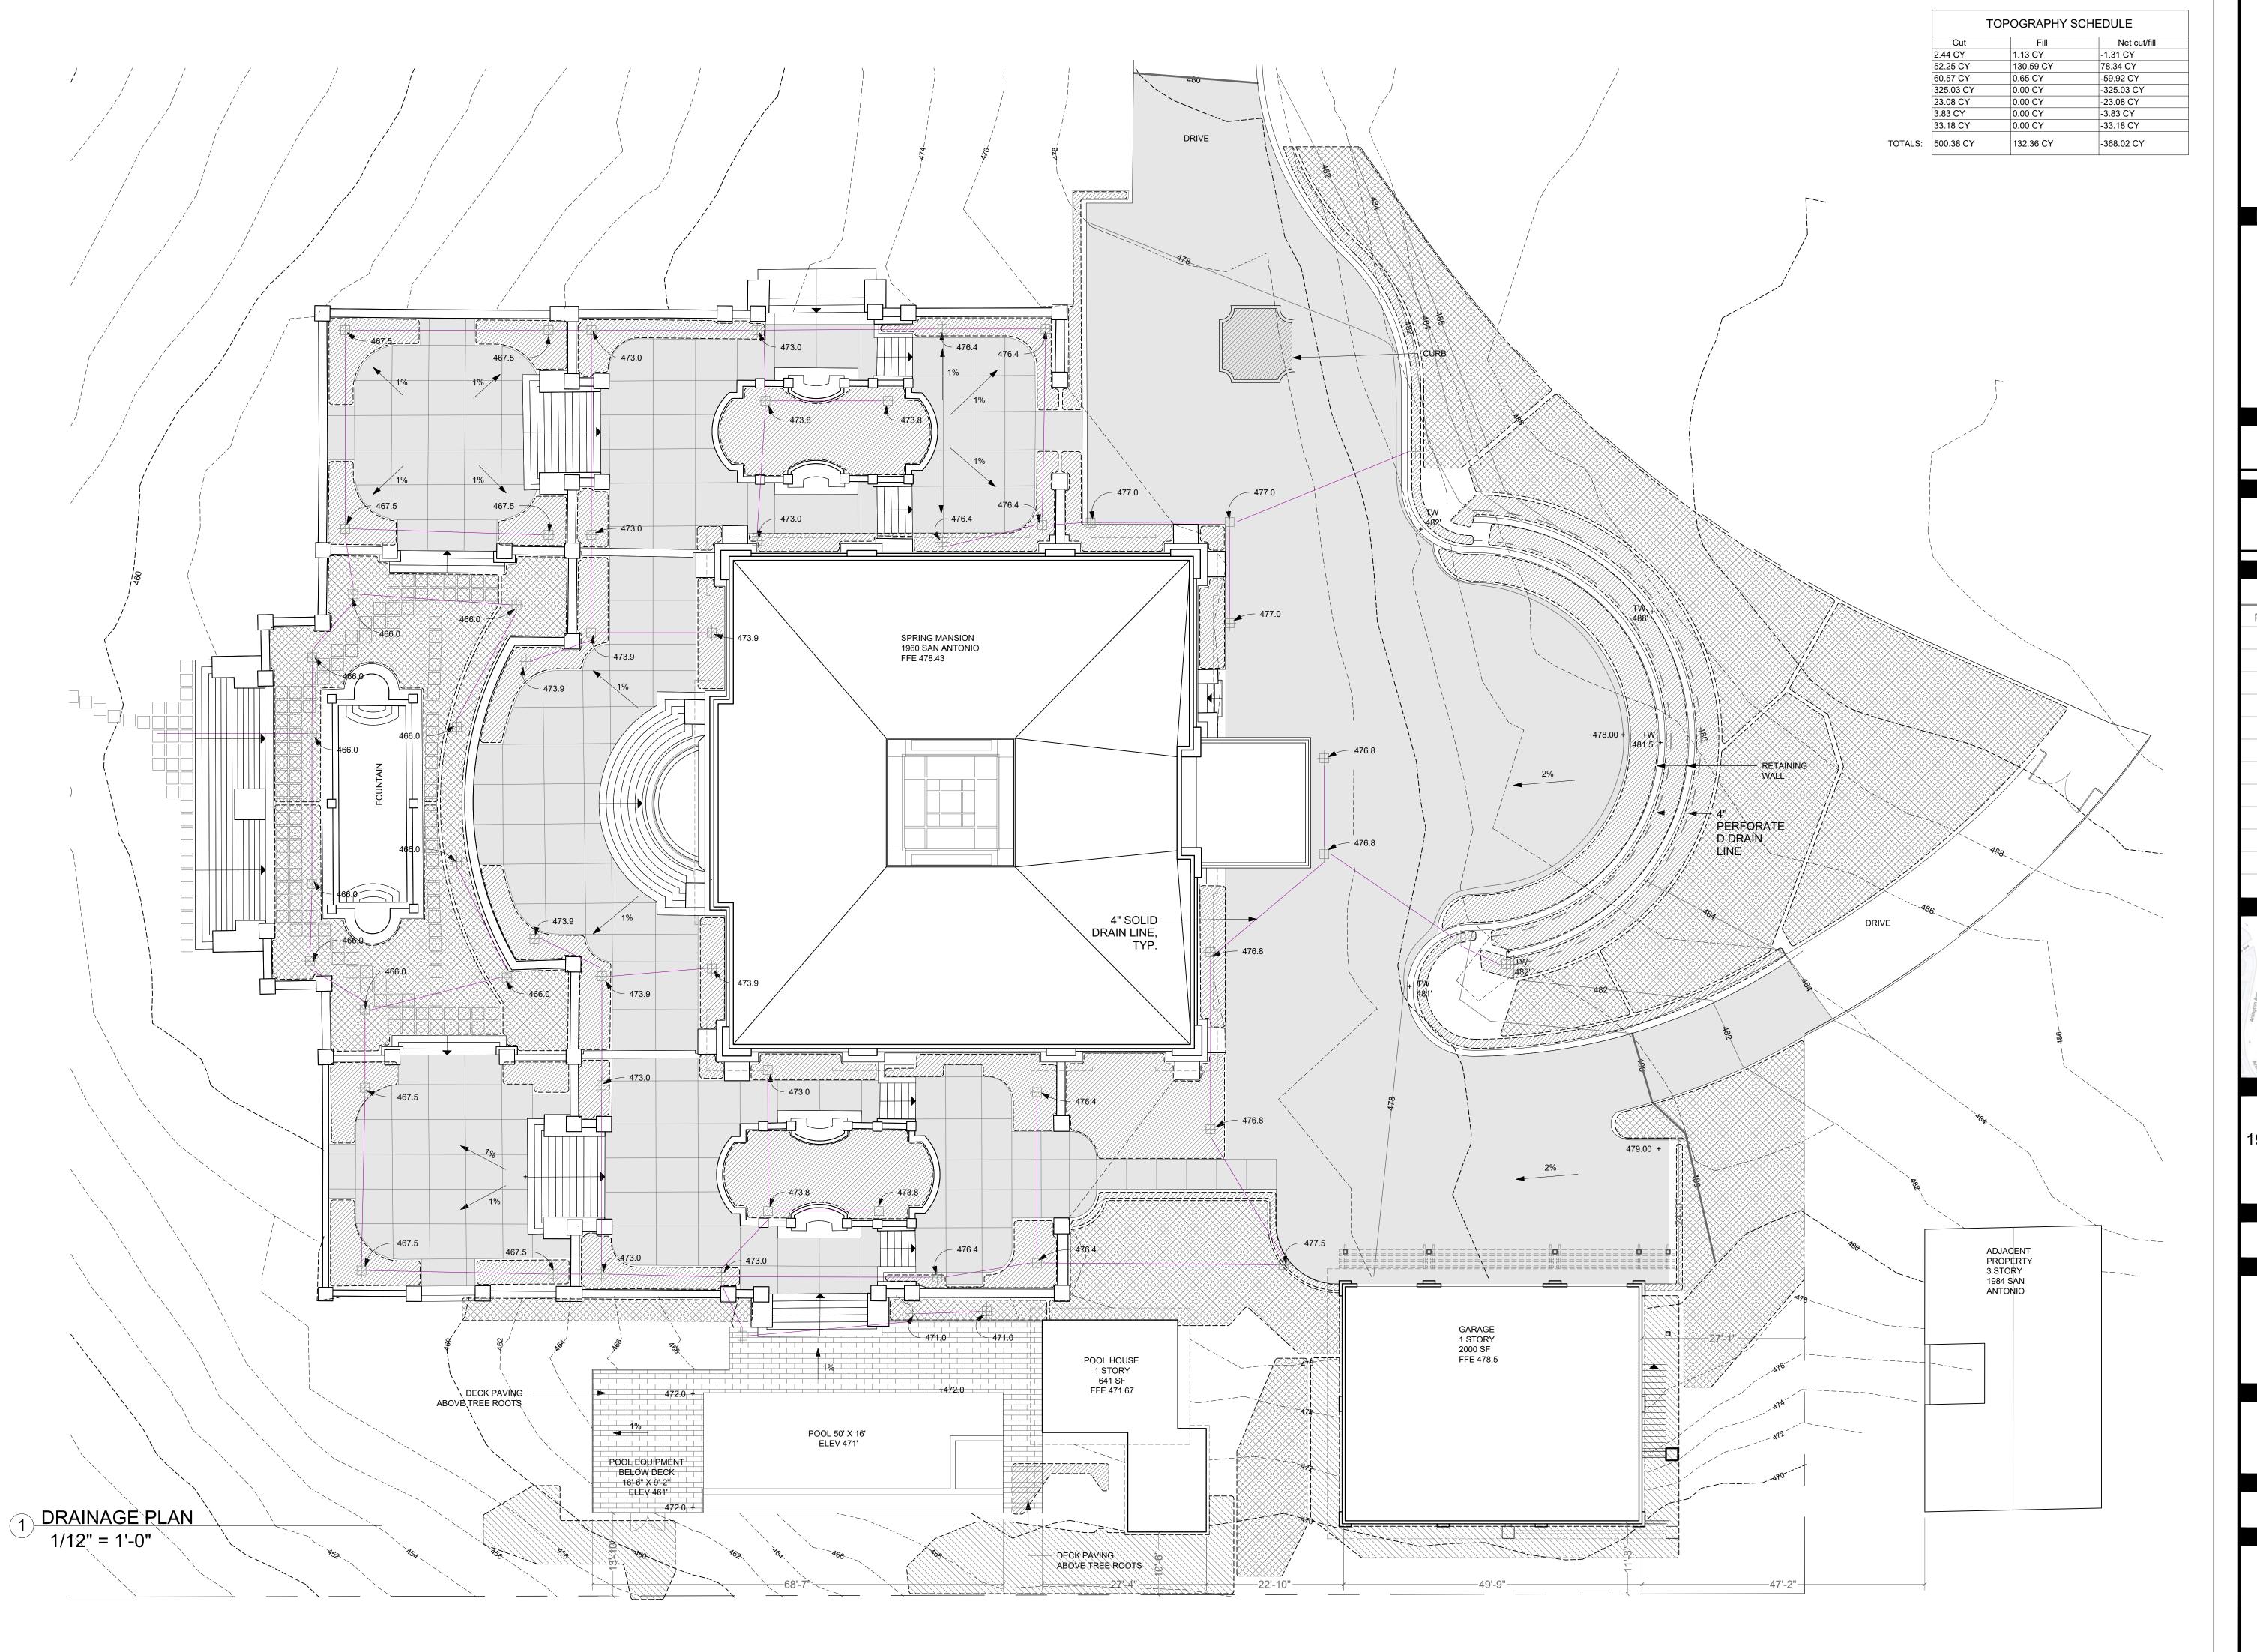

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LEAD DESIGN CONSULTANT

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PLANNING SUBMITTAL I 05/13/202

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AREA

ORIENTATION



SHEET TITLE

**GRADING & DRAINAGE** 

SCALE

AS INDICATED

SHEET NUMBER

L.6



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**SPRING MANSION** 


OWNER(S)

ABBAS MASH

NOTES REVISION

DATE PLANNING SUBMITTAL I

LOCATION

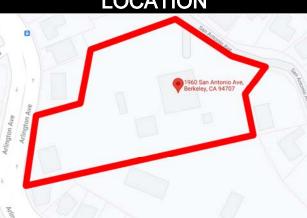

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AREA

ORIENTATION



SHEET TITLE

LOT COVERAGE **EXISTING AND PROPOSED** 

SCALE


AS INDICATED

SHEET NUMBER

Page 25 of 50


FRONT VIEW

FRONT VIEW

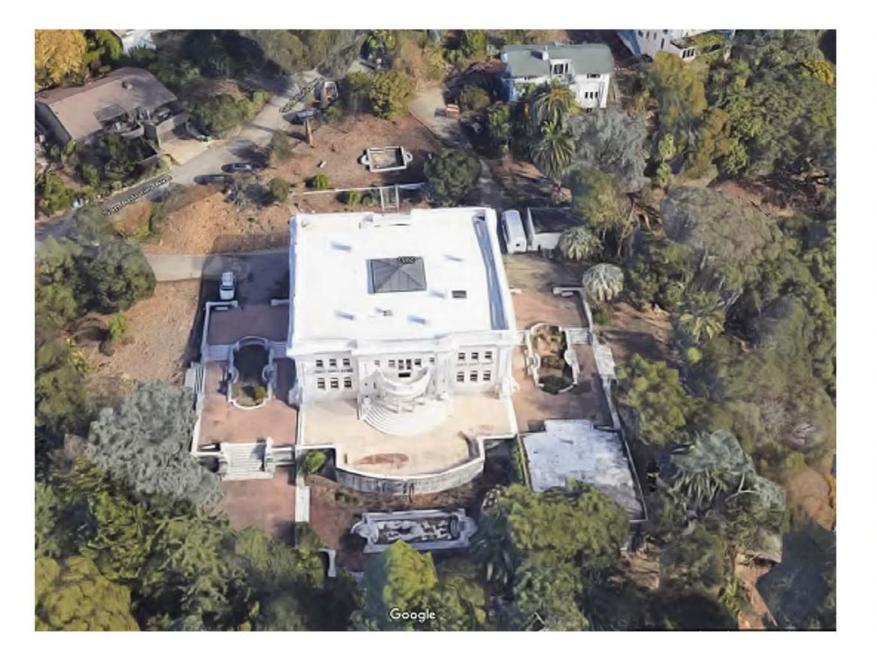





**NORTH VIEW** 

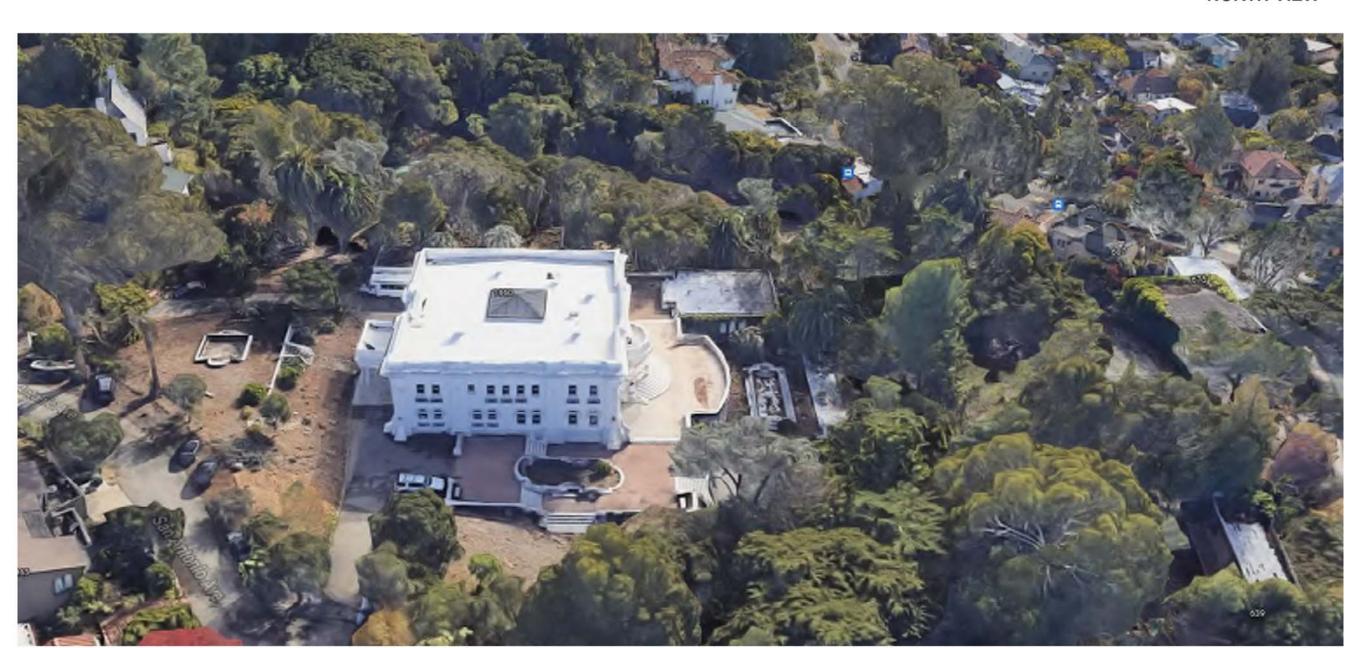




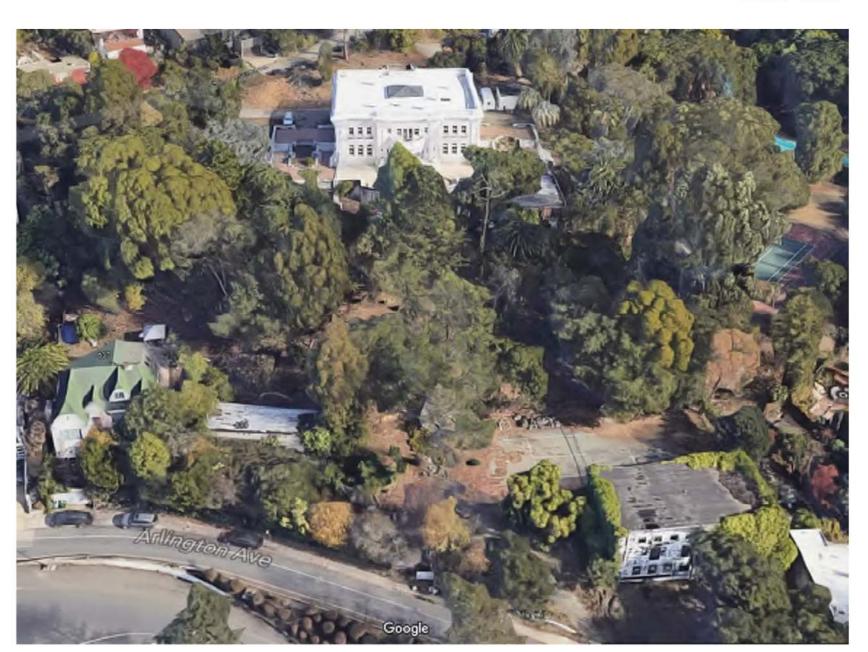

SOUTH VIEW

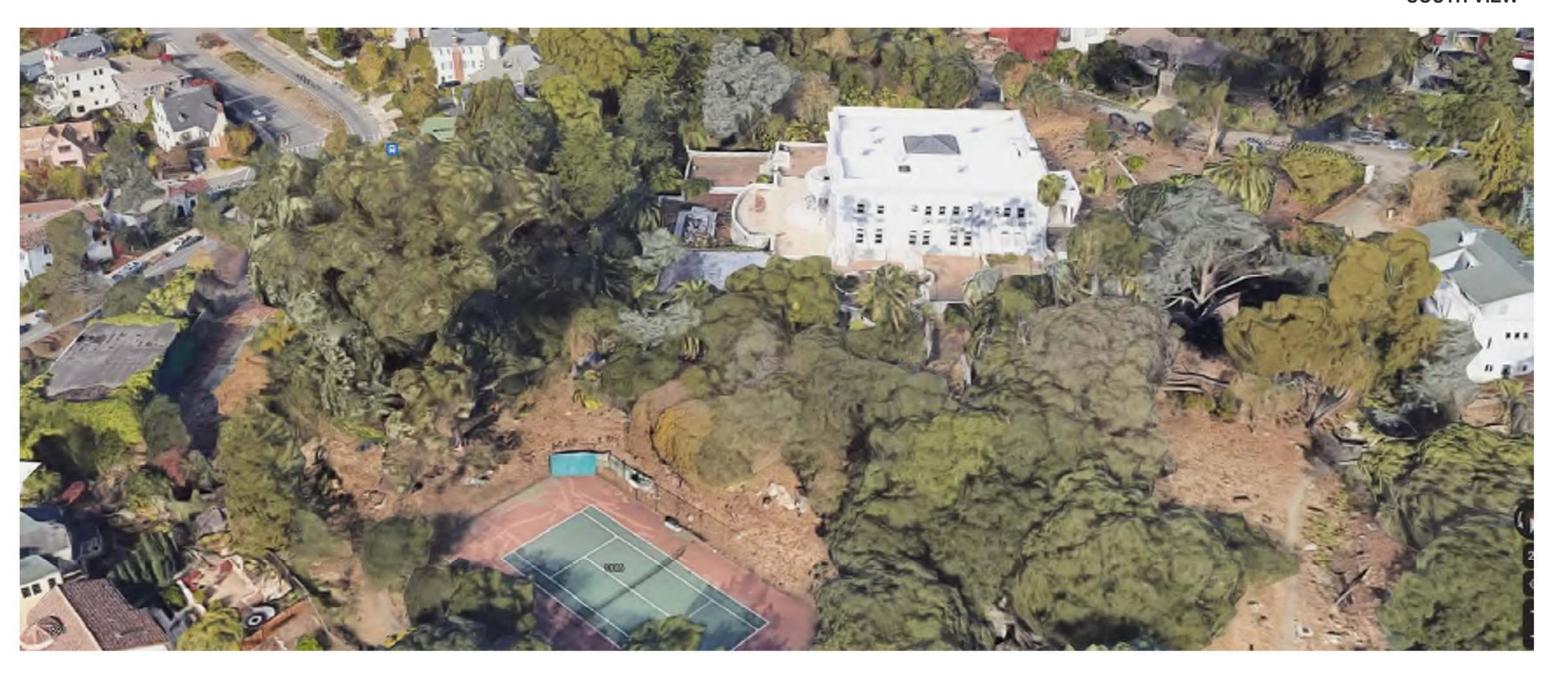

**EAST VIEW** 

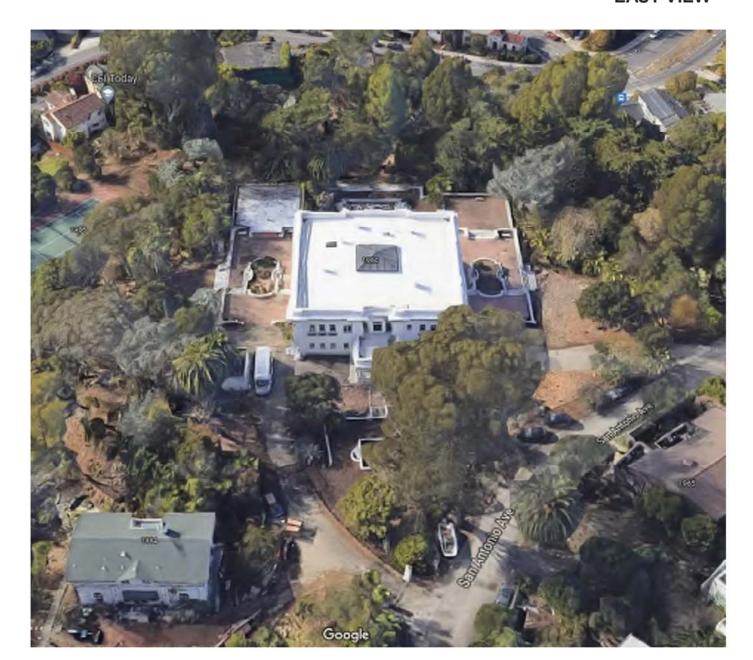

# PAYMUN.

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## LEAD DESIGN CONSULTANT

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DESIGNER & DRAFTER : SADAF DAYLAMI

## PROJECT

SPRING MANSION


## OWNER(S)

ABBAS MASH

## NOTES

REVISION	DATE
ANNING SUBMITTAL I	05/13/2023

## LOCATION

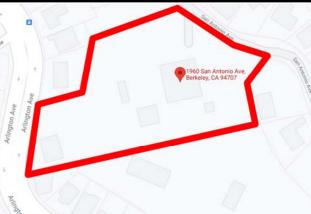

## ADDRESS

1960 SAN ANTONIO AVENUE BERKELEY, CA 94707

## AREA

ORIENTATION

## SHEET TITLE


PHOTOS

## SCALE


AS INDICATED
SHEET NUMBER





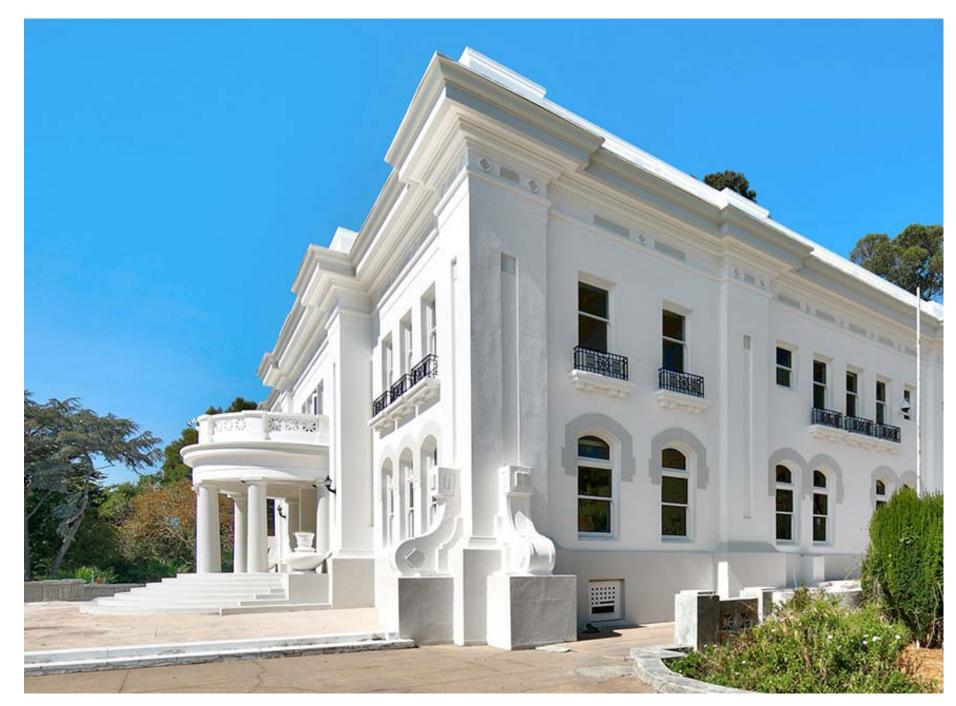



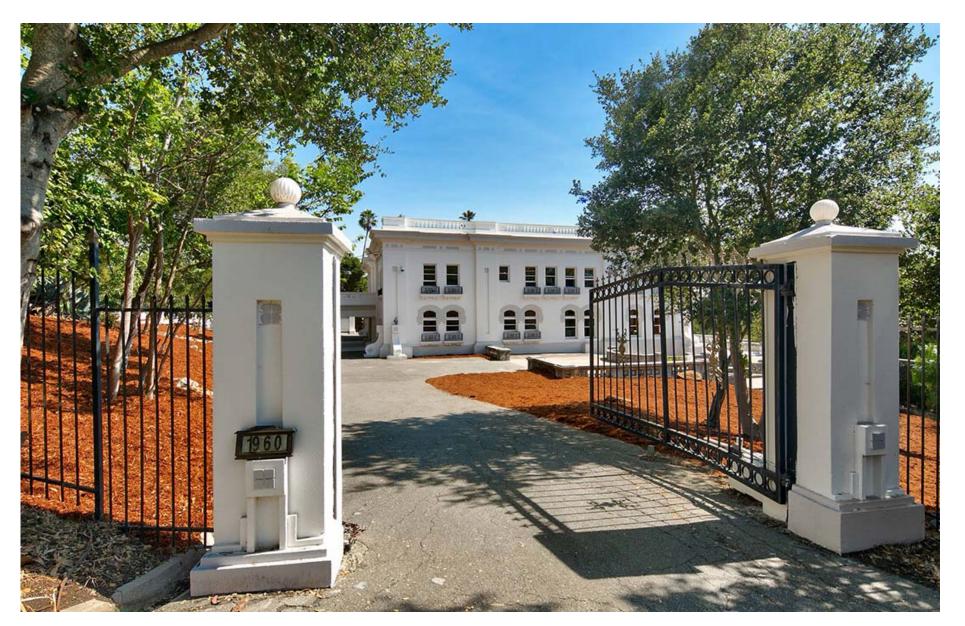



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## LEAD DESIGN CONSULTANT

PAYMUN BUILDING & DEVELOPMENT, Inc.

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SPRING MANSION

PROJECT

OWNER(S)

ABBAS MASH

NOTES

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LOCATION



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AREA

ORIENTATION

SHEET TITLE

PHOTOS (MAIN HOUSE)

SCALE

AS INDICATED

SHEET NUMBER
















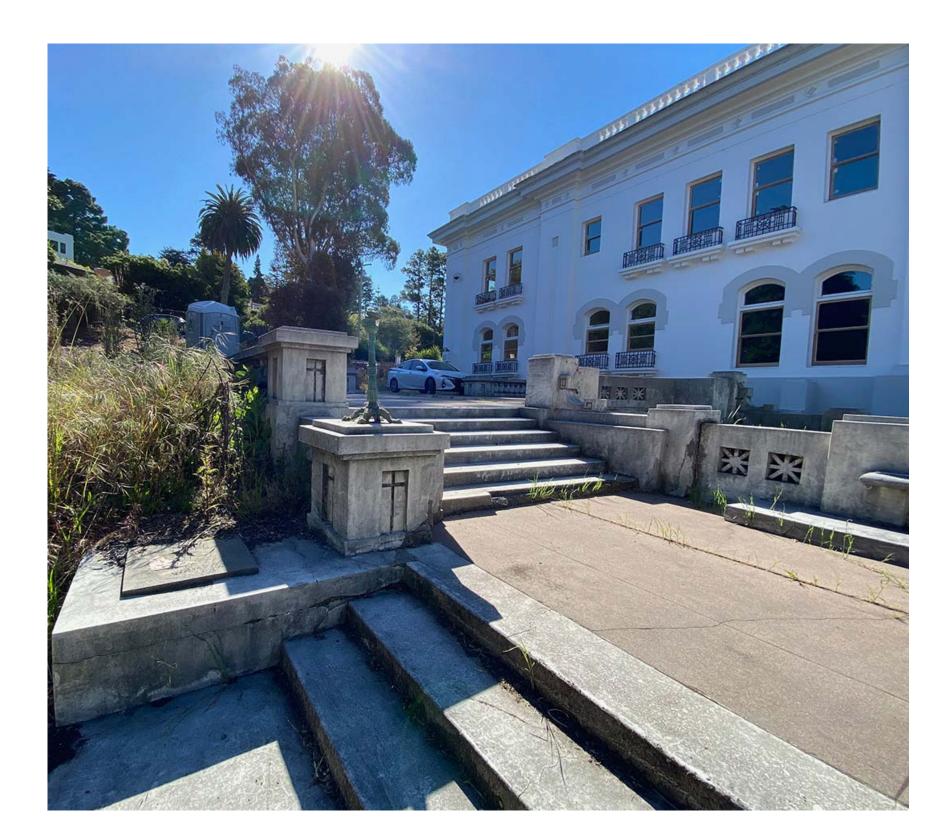

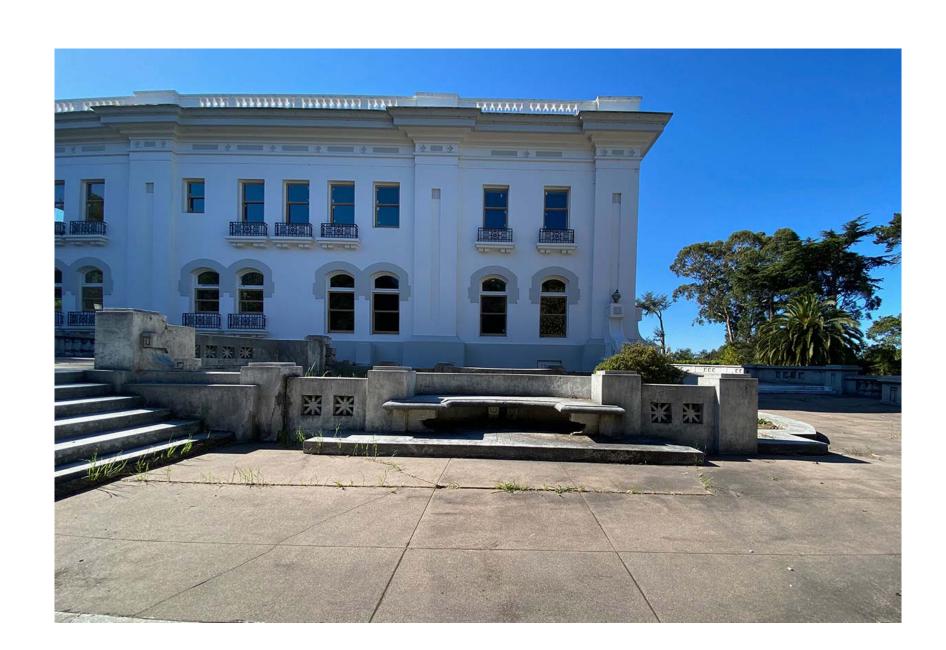

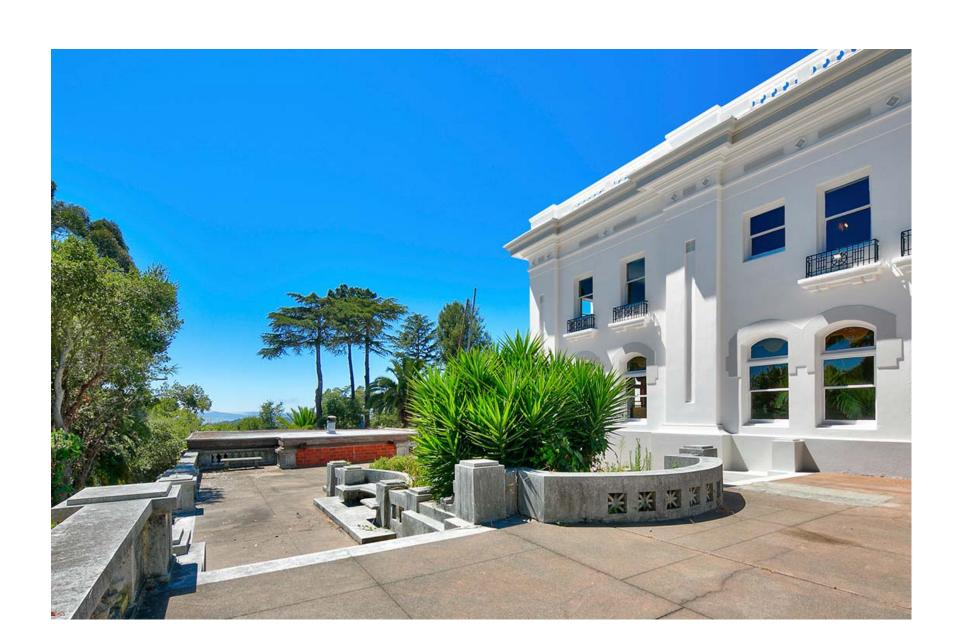

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PROJECT

SPRING MANSION

OWNER(S)


ABBAS MASH

NOTES

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ORIENTATION


SHEET TITLE

PHOTOS (OUTDOOR)

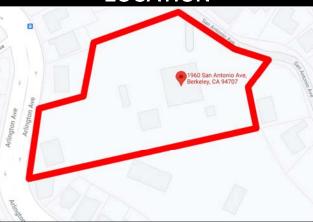SCALE

AS INDICATED

SHEET NUMBER

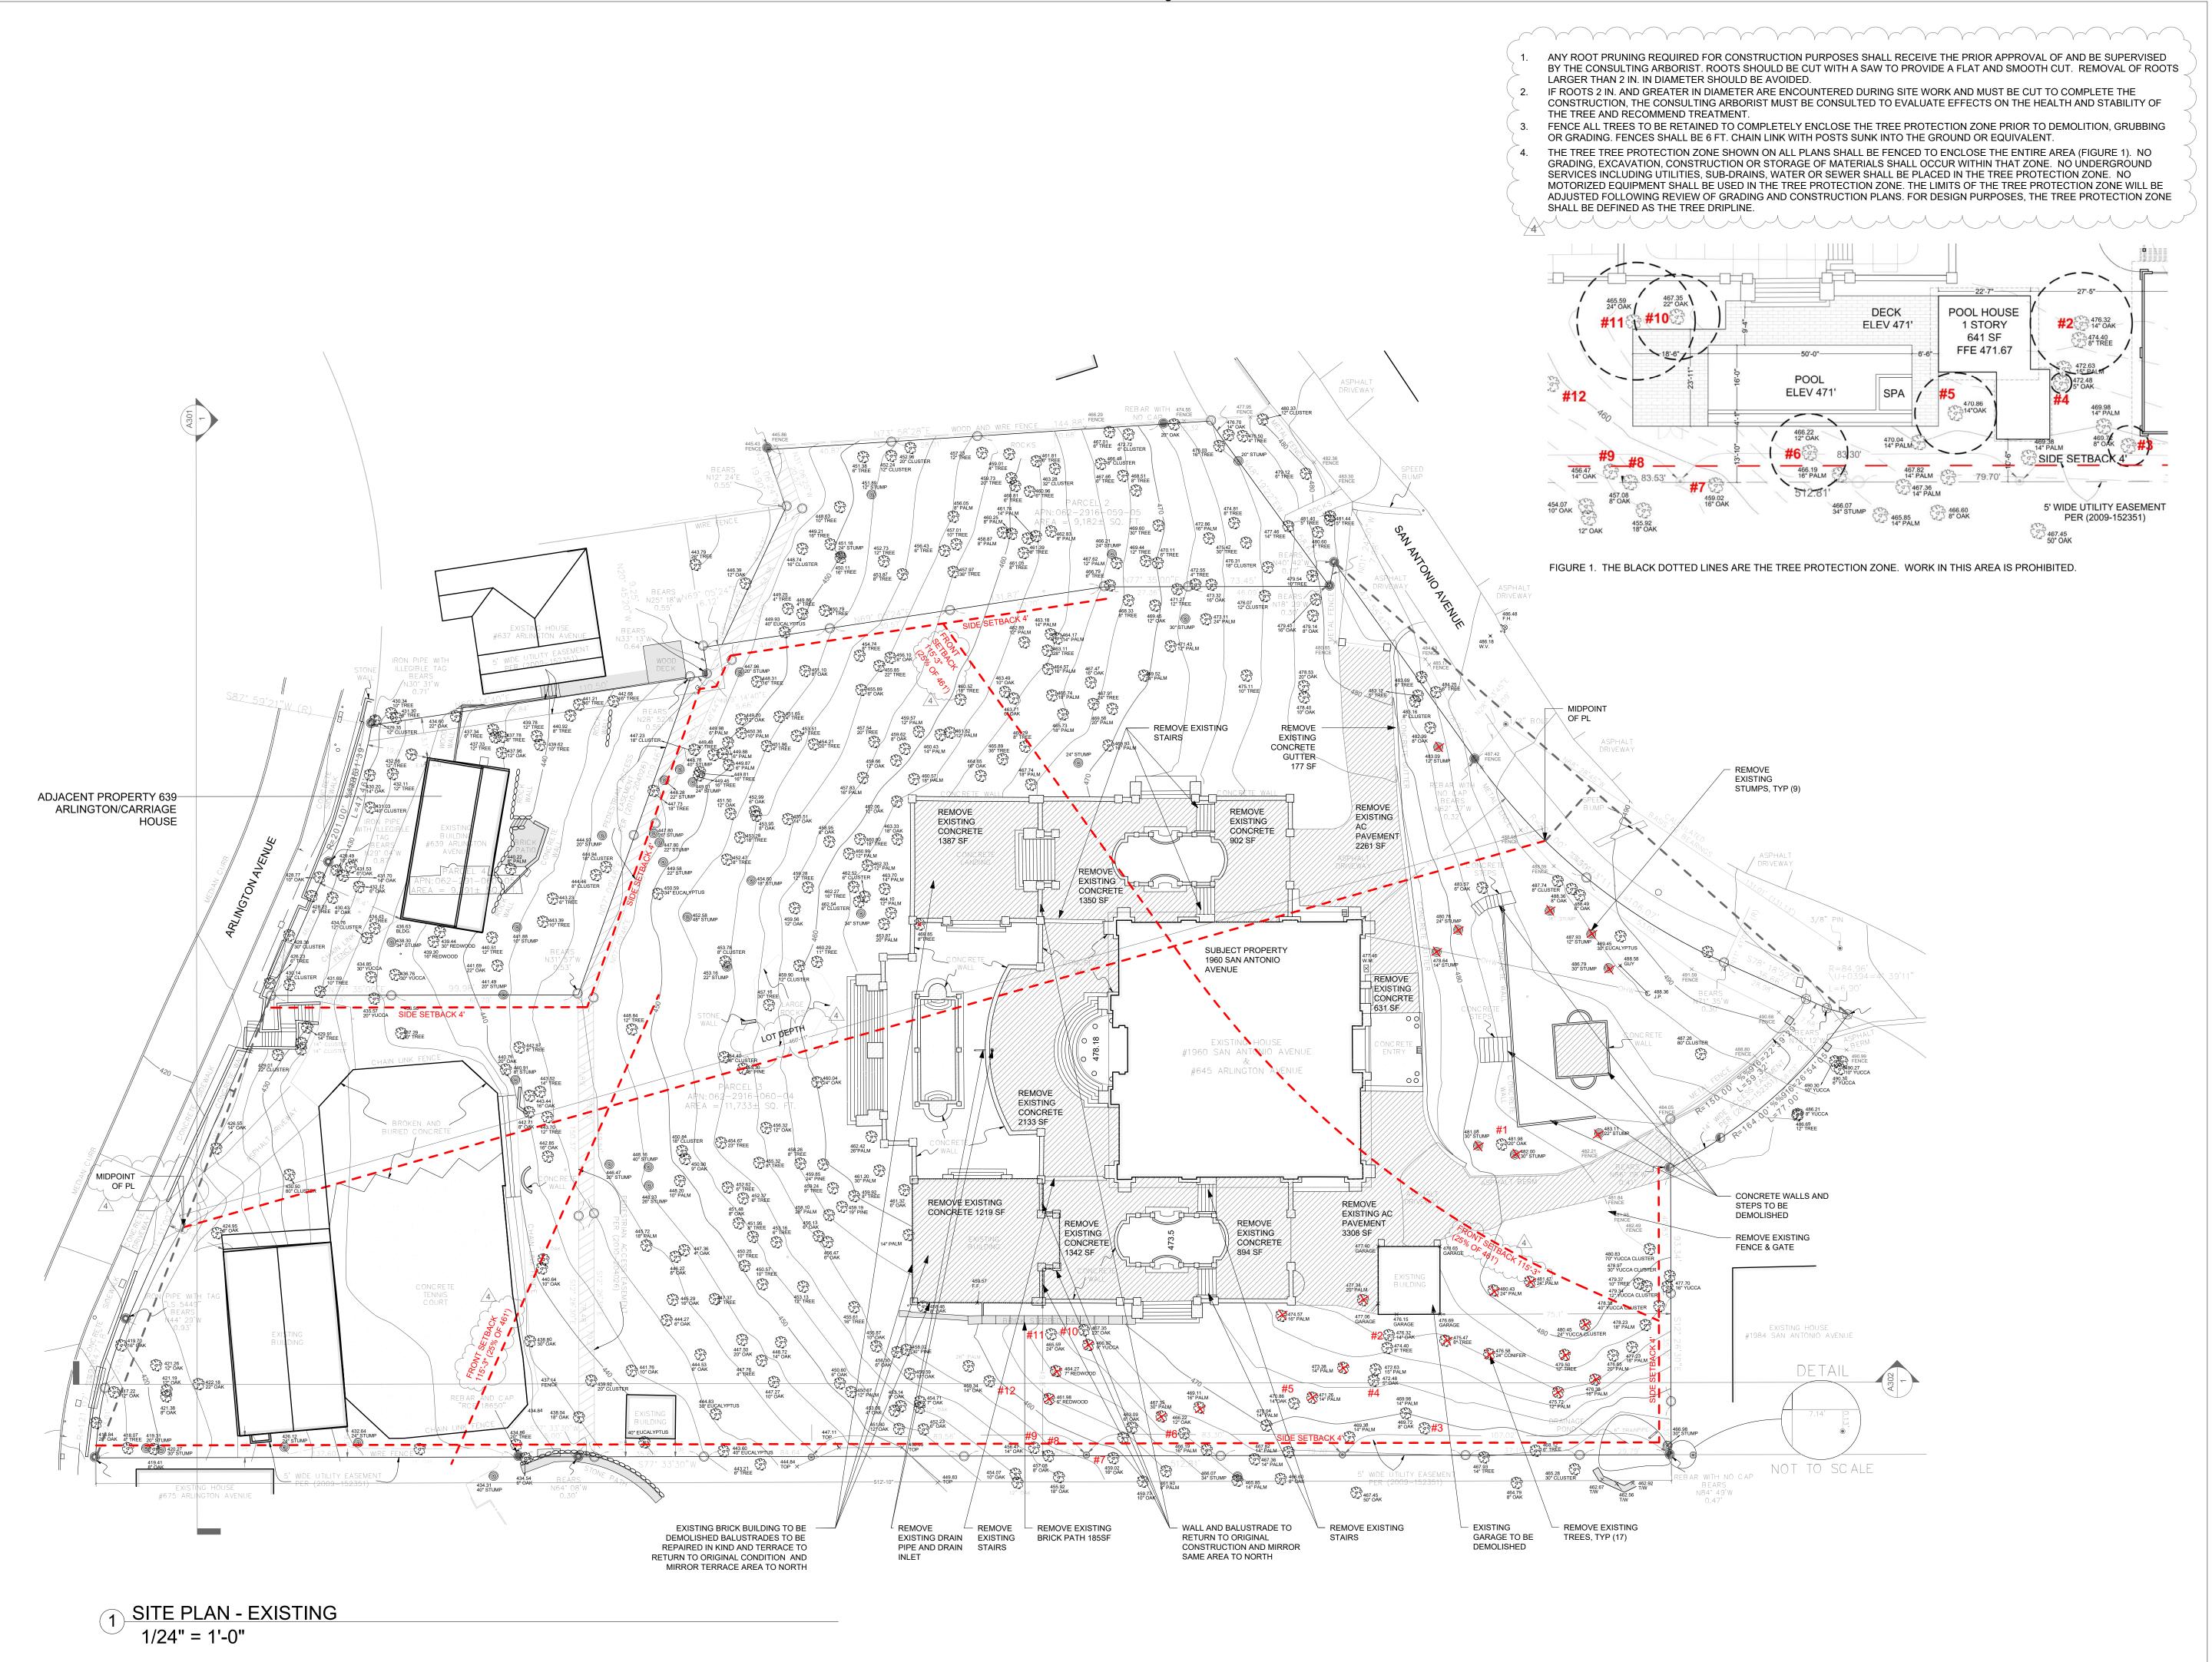

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Ben@paymun.com

LEAD DESIGN CONSULTANT

PAYMUN BUILDING & DEVELOPMENT, Inc.

DESIGNER & DRAFTER :
SADAF DAYLAMI

DAF DATLAMI

PROJECT

SPRING MANSION

OWNER(S)

ABBAS MASH

NOTES

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ORIENTATION




SHEET TITLE

SITE PLAN - EXISTING

SCALE

AS INDICATED

SHEET NUMBER

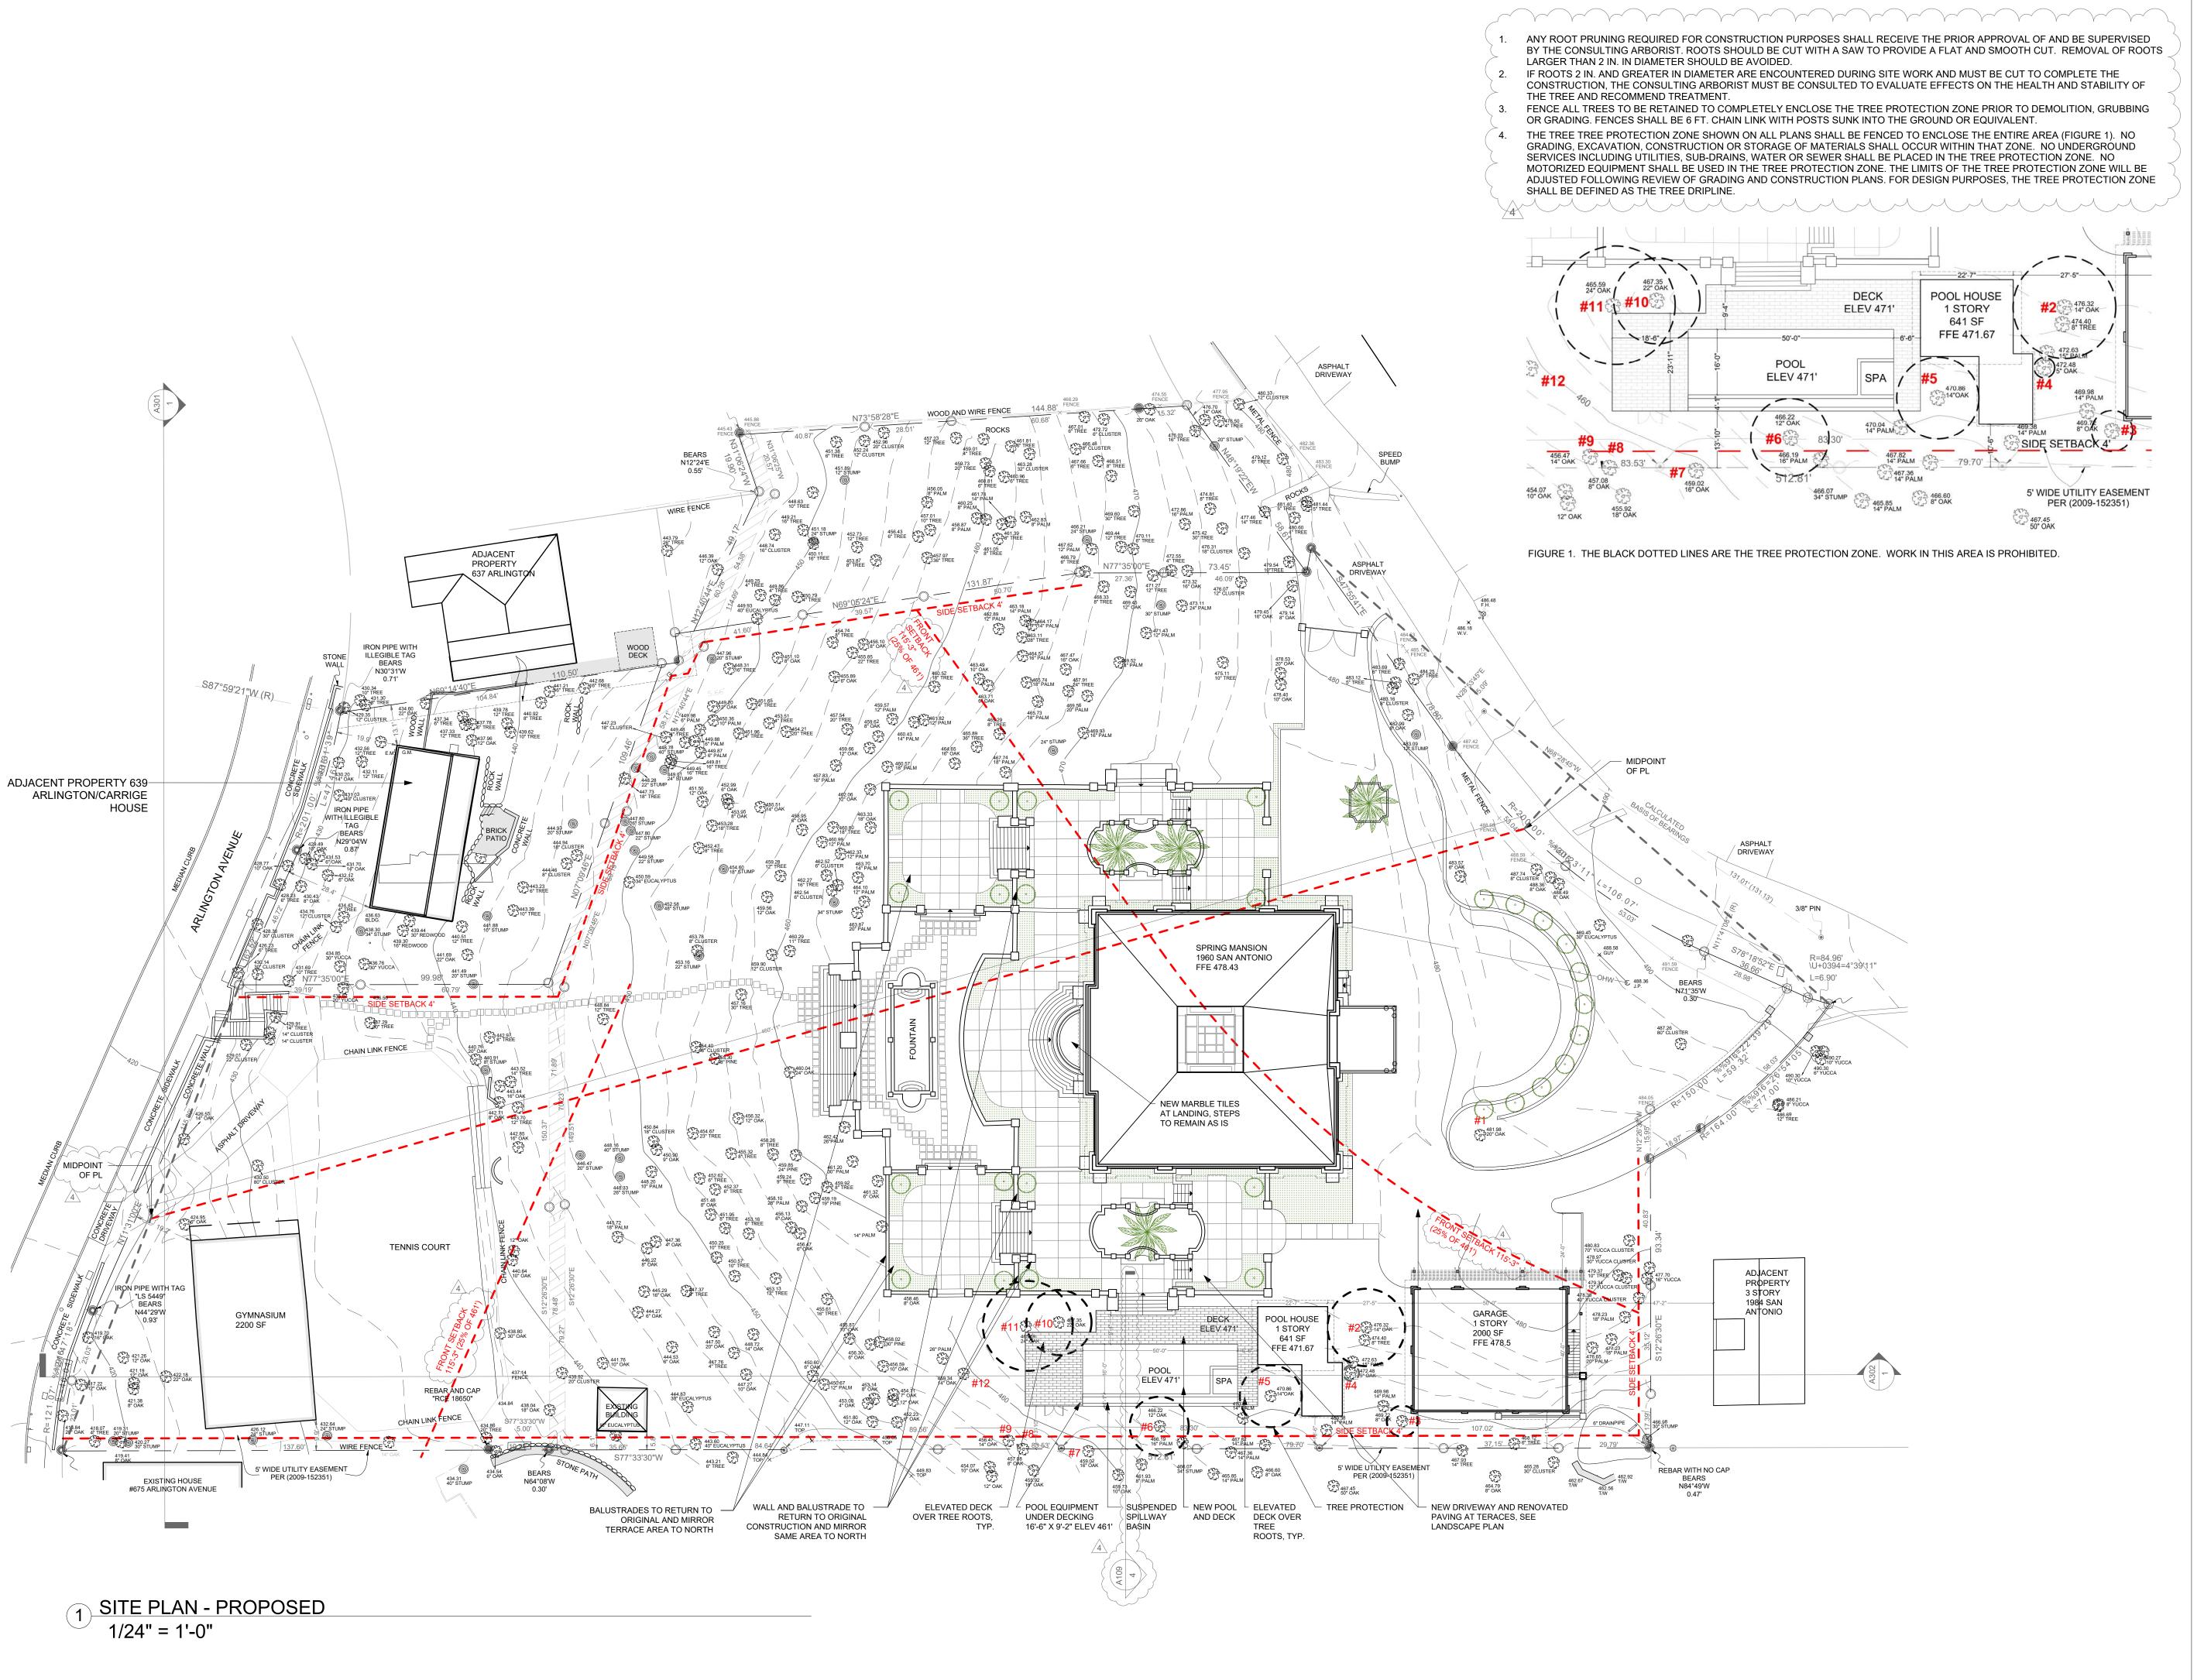

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LEAD DESIGN CONSULTANT

PAYMUN BUILDING & DEVELOPMENT, Inc.

DESIGNER & DRAFTER :
SADAF DAYLAMI

**PROJECT** 

SPRING MANSION

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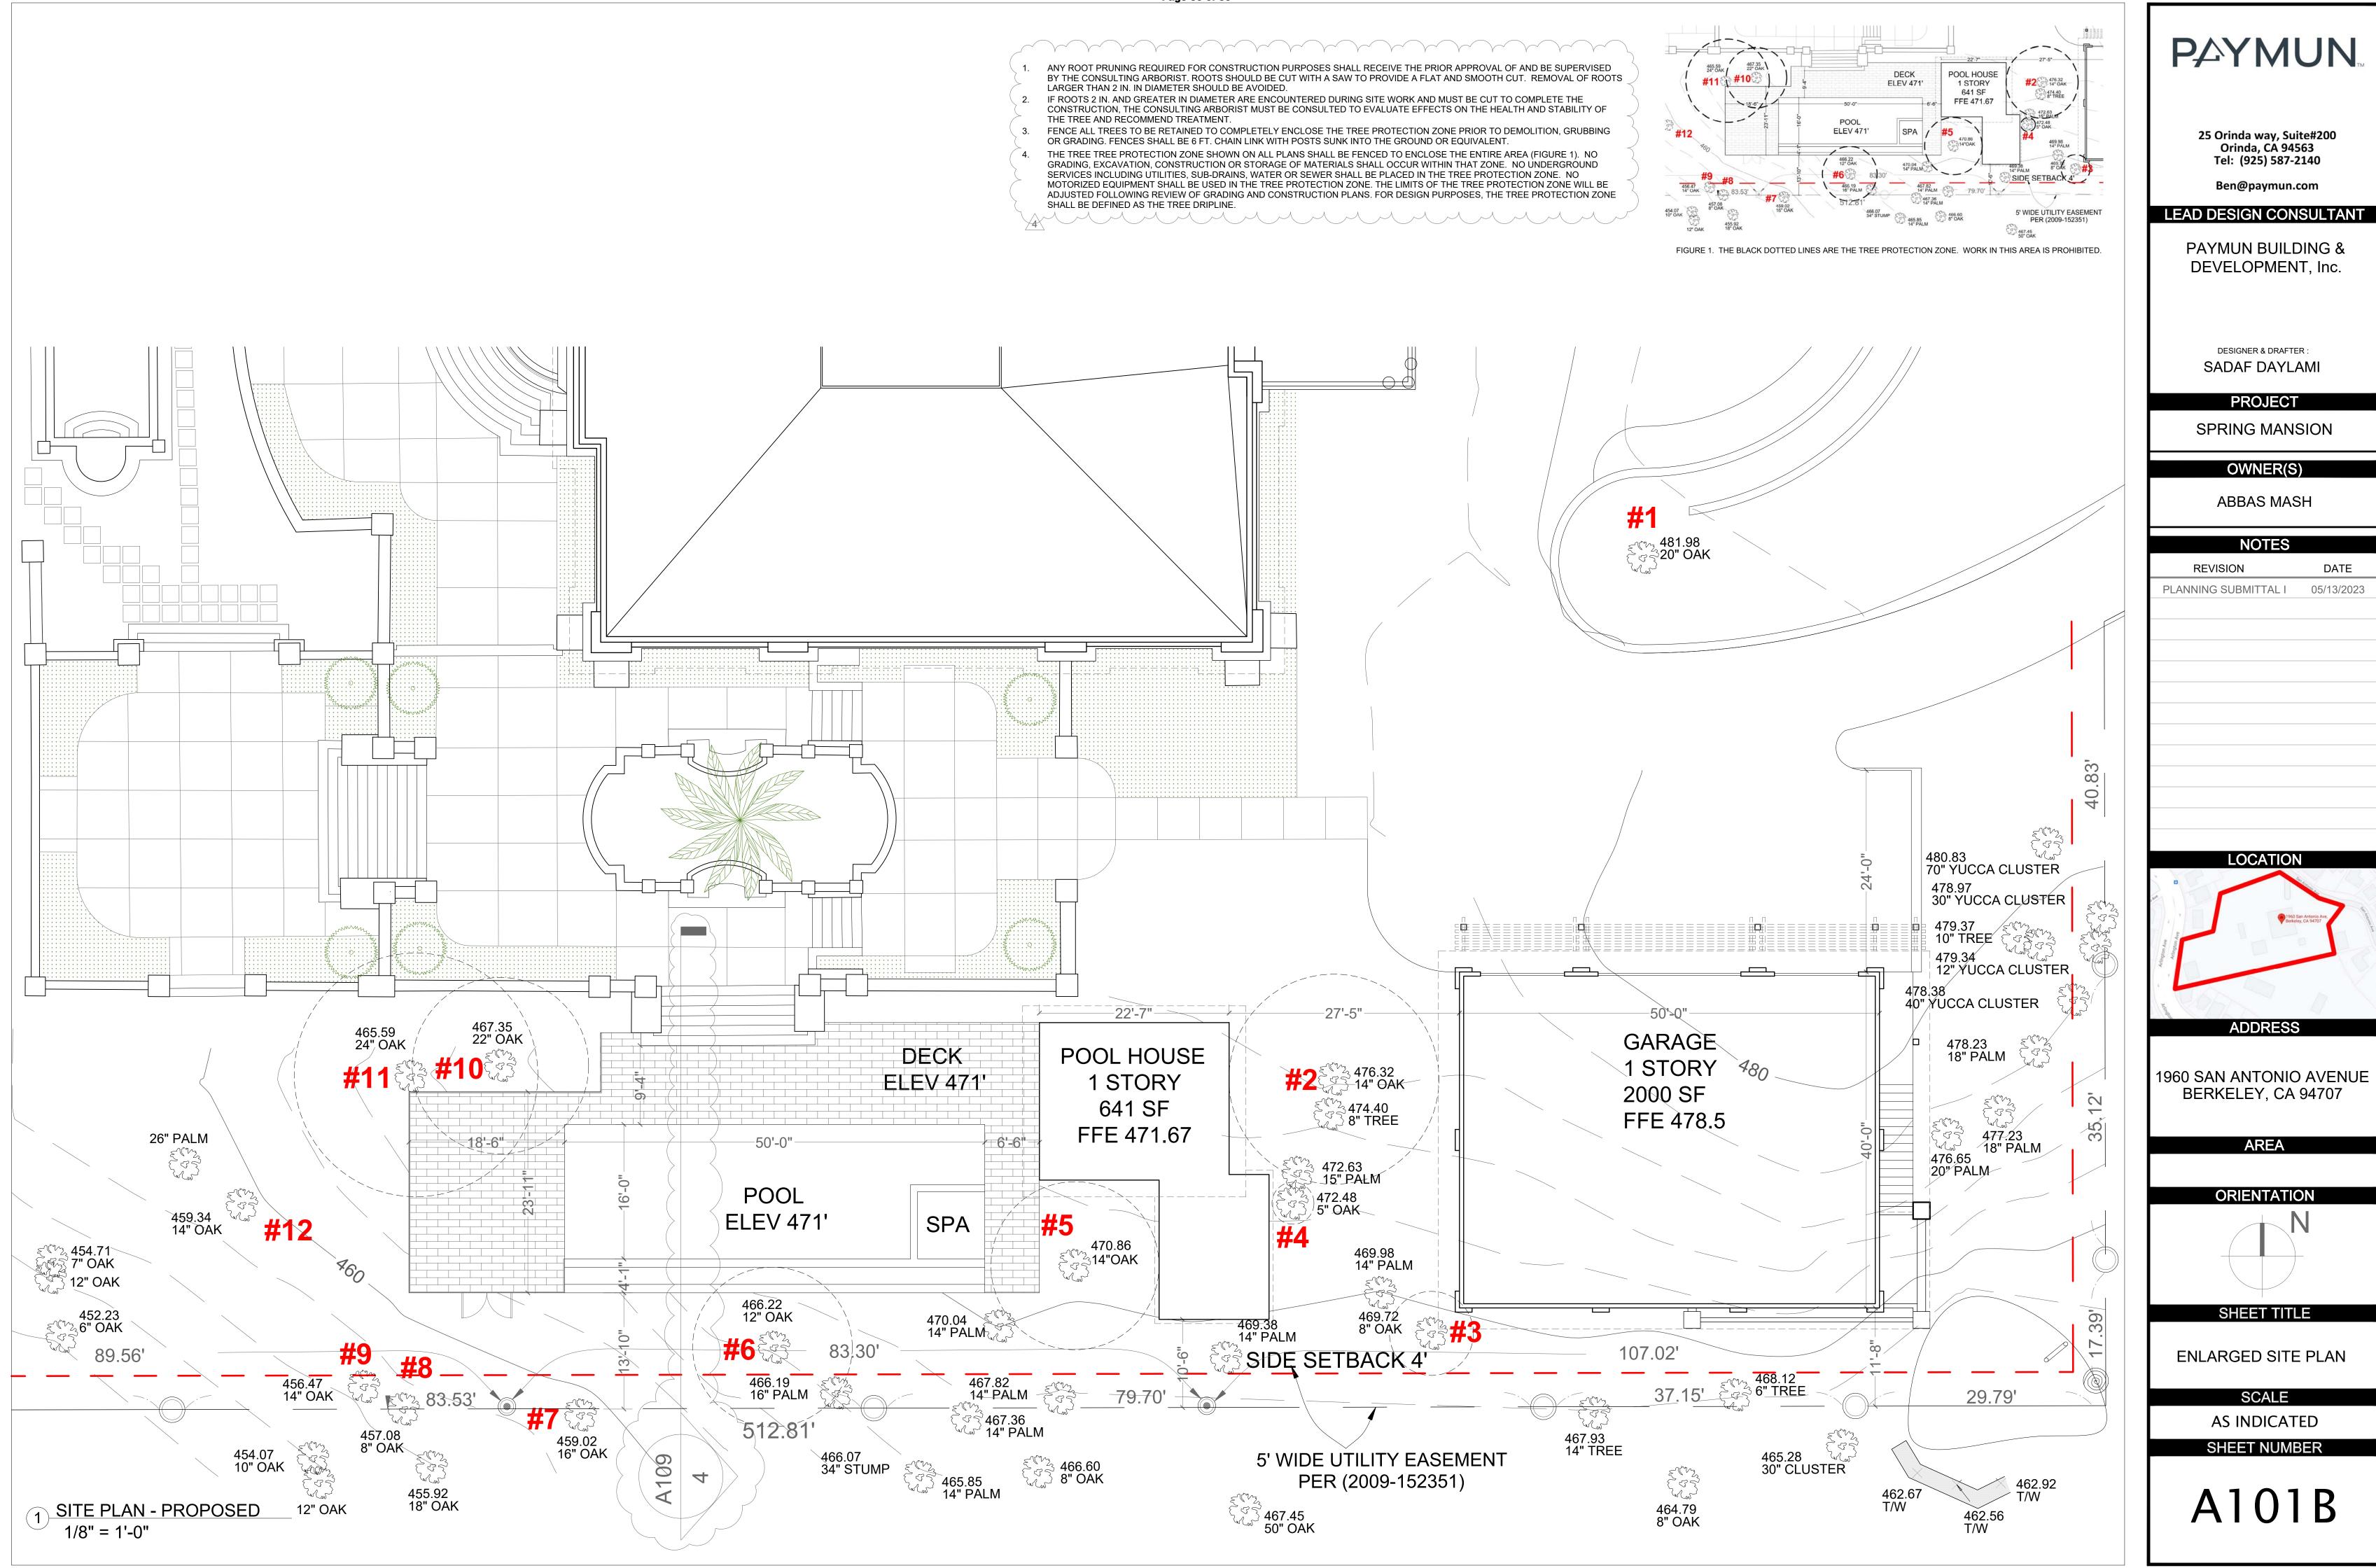
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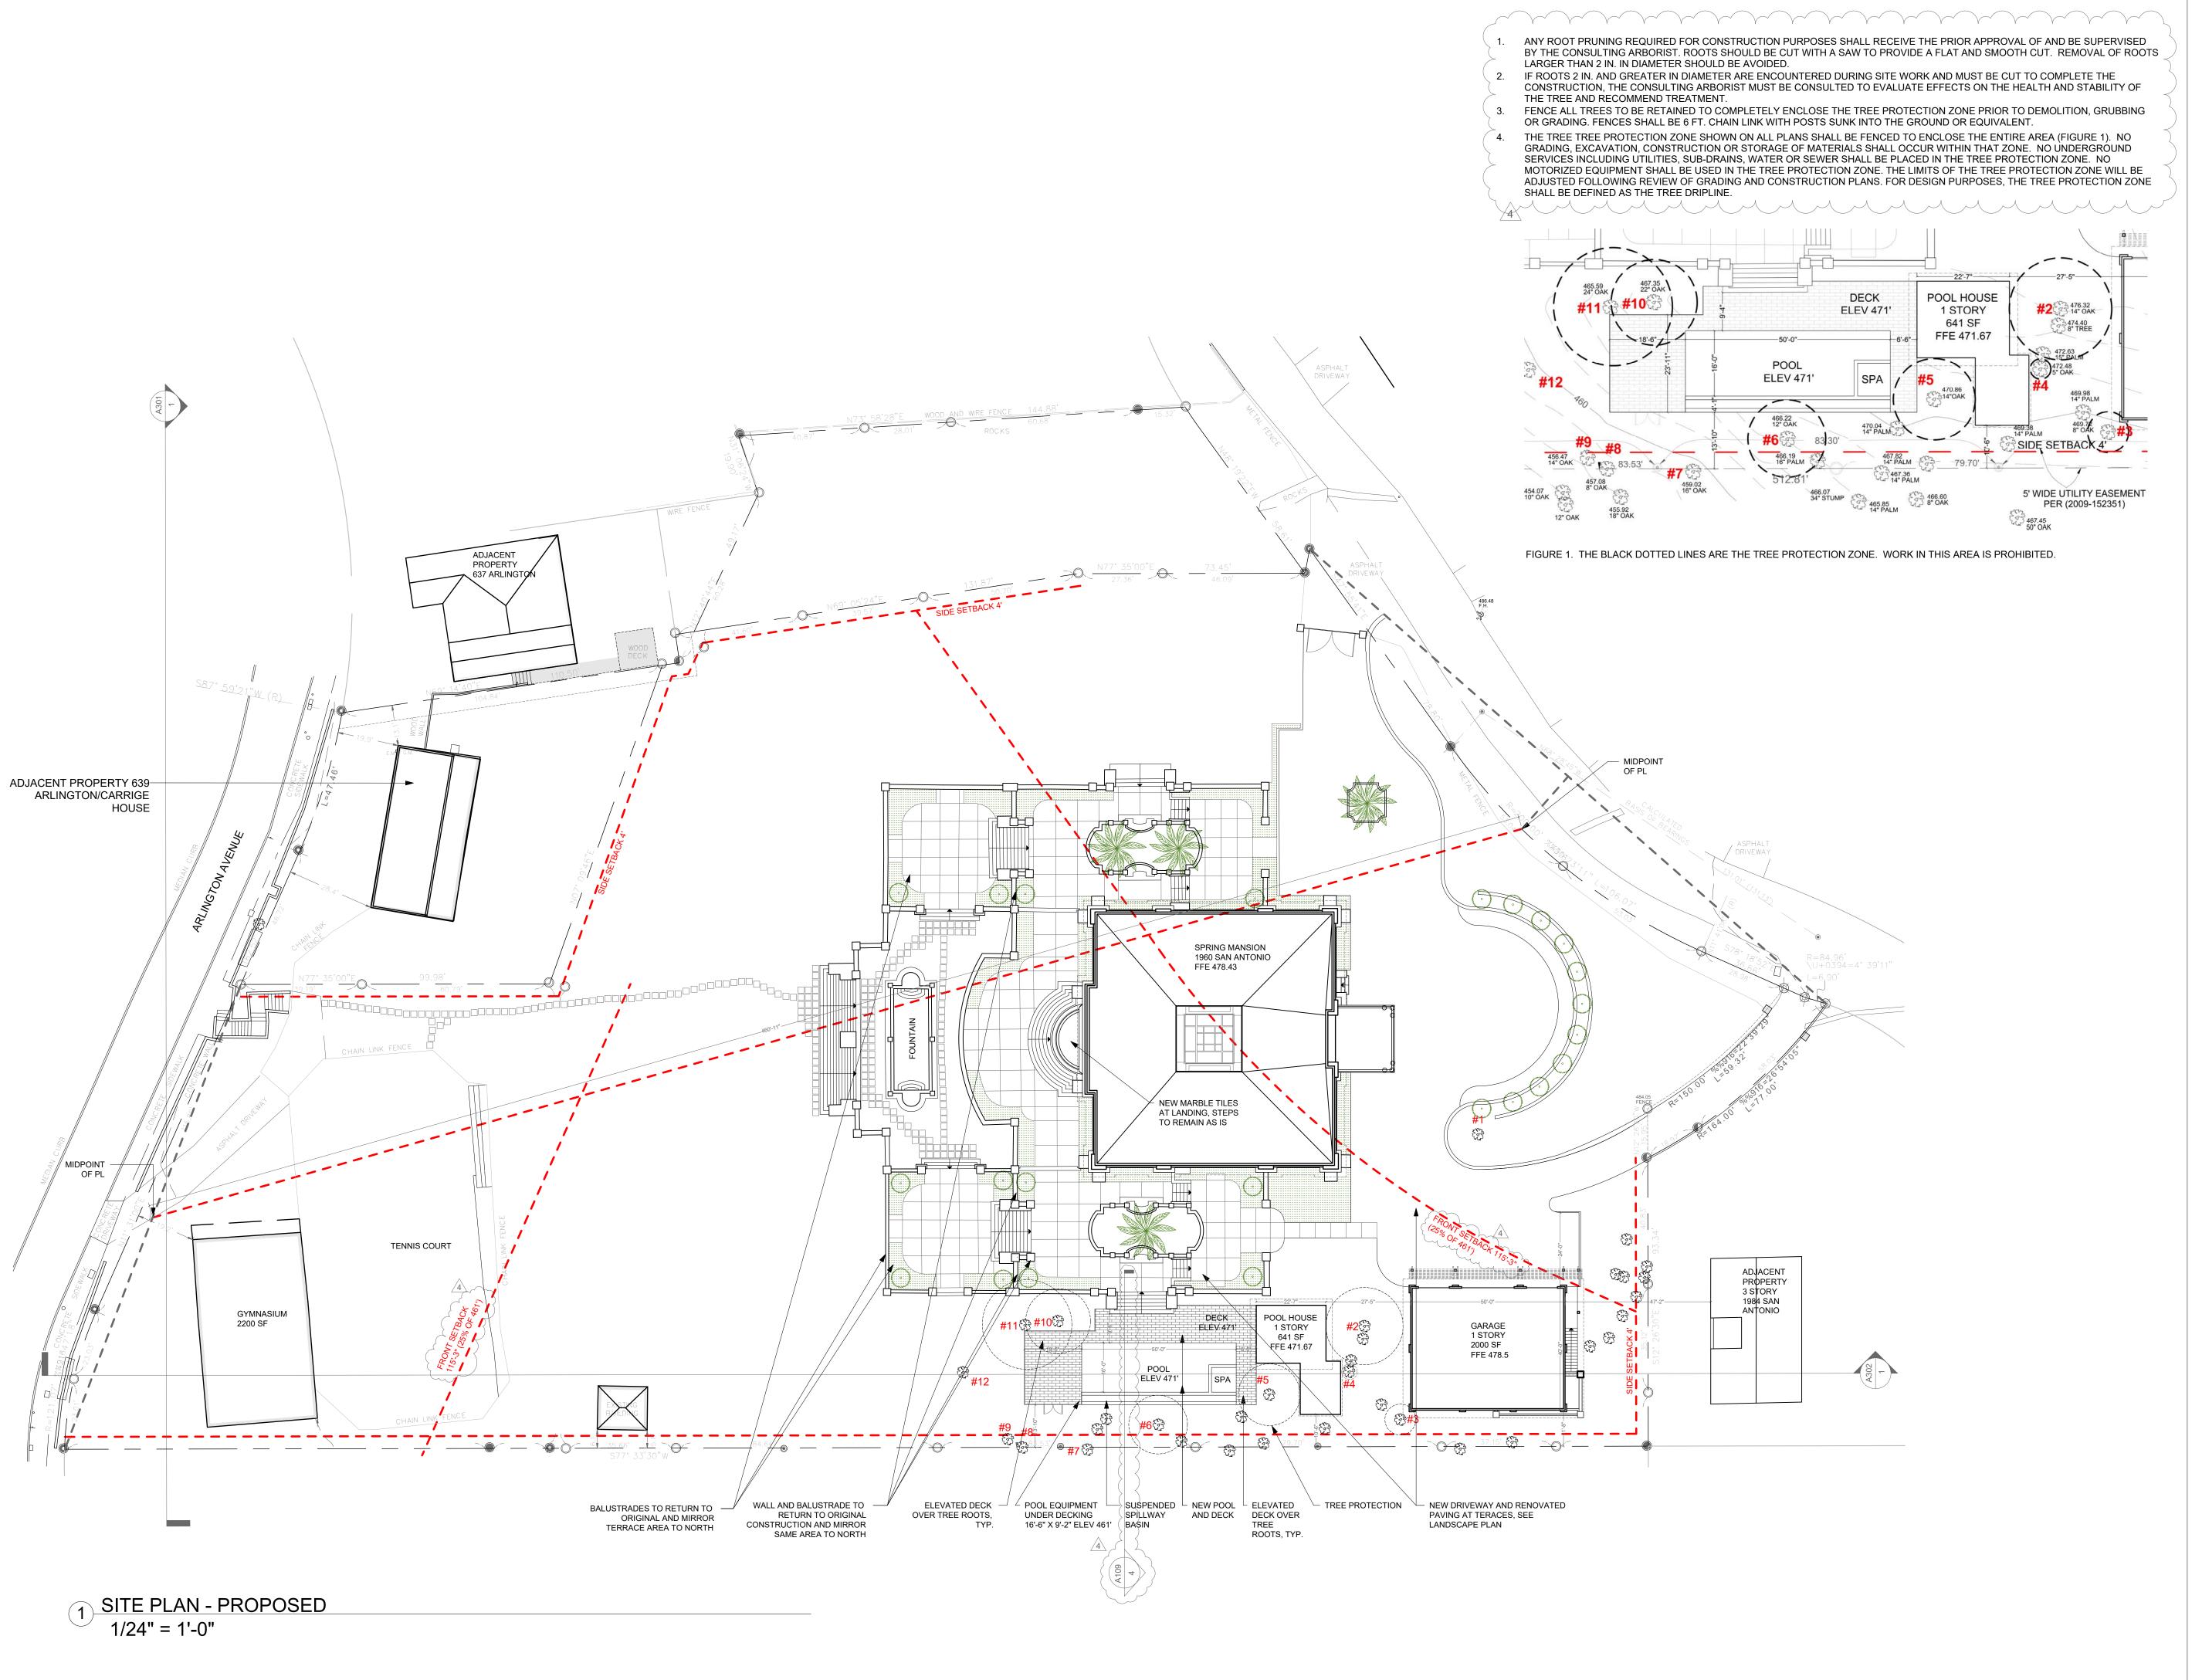
SITE PLAN - PROPOSED

SCALE

**AS INDICATED** 

SHEET NUMBER





25 Orinda way, Suite#200 Orinda, CA 94563 Tel: (925) 587-2140

Ben@paymun.com

#### LEAD DESIGN CONSULTANT

PAYMUN BUILDING & DEVELOPMENT, Inc.

DESIGNER & DRAFTER :
SADAF DAYLAMI

**PROJECT** 

SPRING MANSION

OWNER(S)

ABBAS MASH

NOTES REVISION

PLANNING SUBMITTAL I 05/13/2023

DATE

LOCATION




ADDRESS

1960 SAN ANTONIO AVENUE BERKELEY, CA 94707

AREA

ORIENTATION

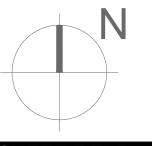

SHEET TITLE

SITE PLAN - SIMPLIFIED

SCALE

**AS INDICATED** 

SHEET NUMBER

A101C


WALL LEGEND

DEMOLISHED WALL **NEW WALL** 


1 HOUR RATED WALL

NOTES:

ALL NEW WALLS TO MATCH EXISTING FINISH, BASEBOARD AND MOLDING

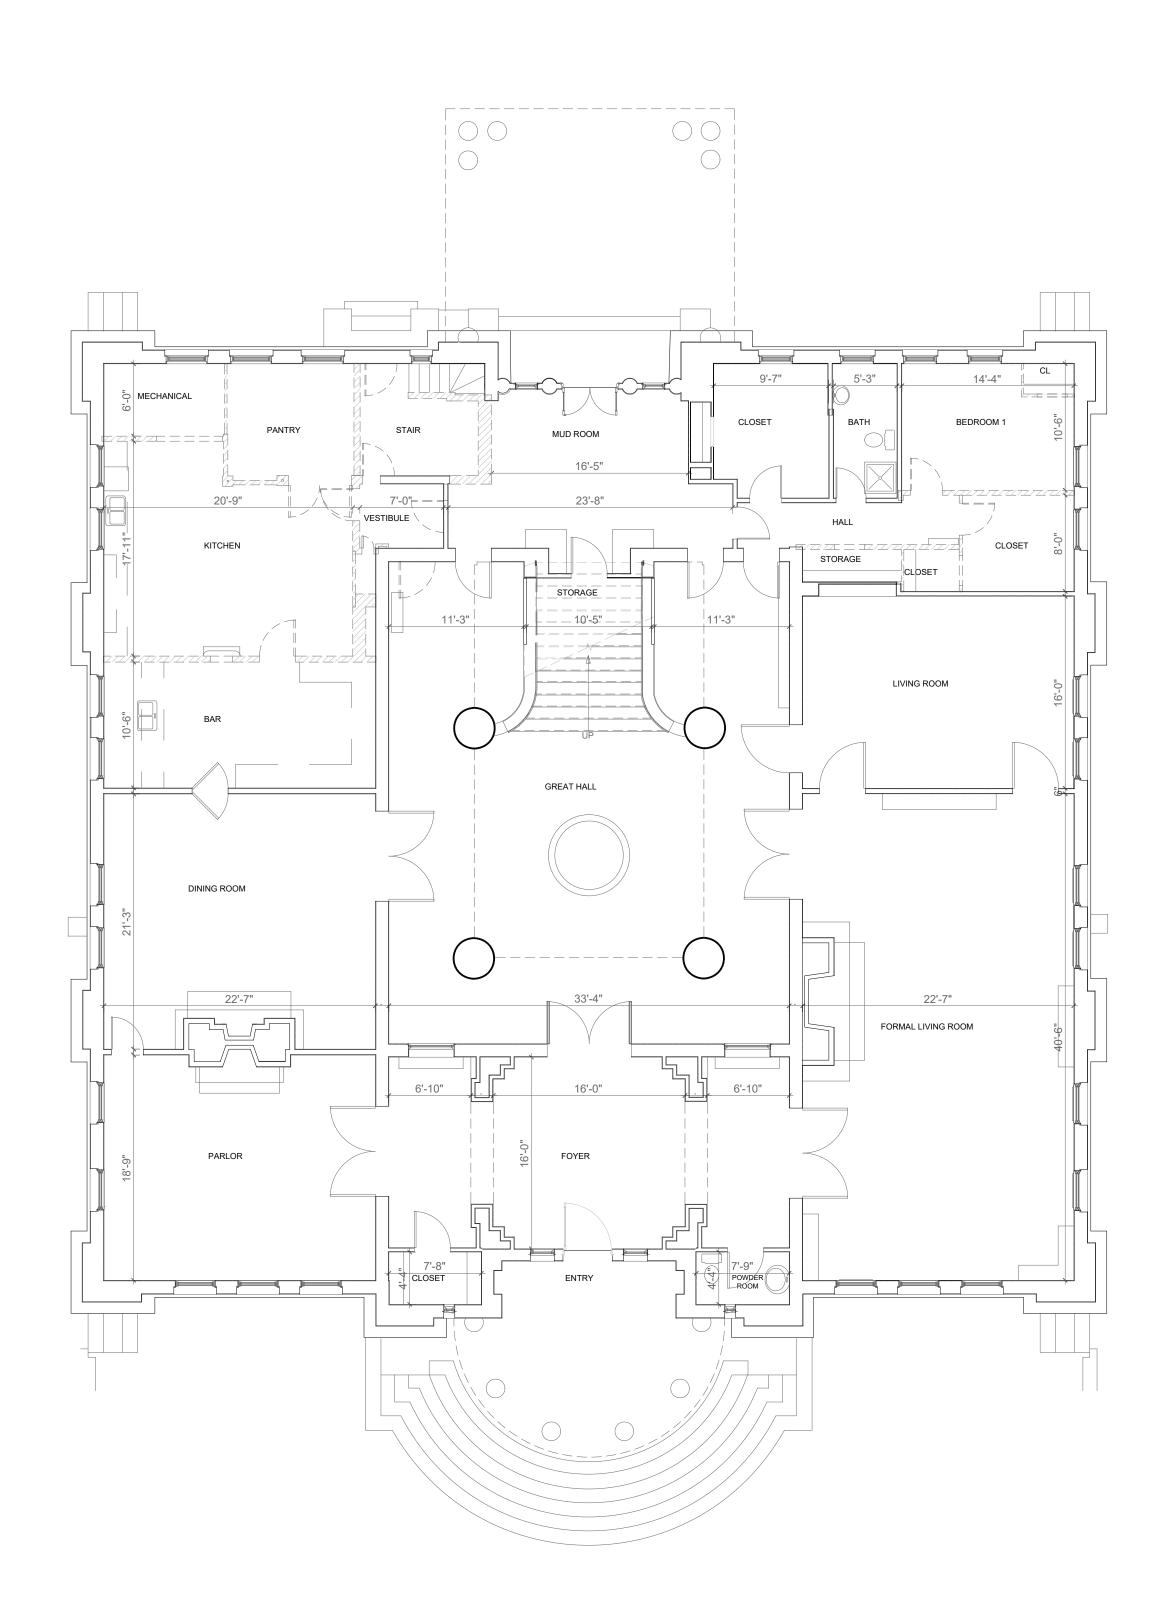

1 1ST FLOOR EXISTING 1/8" = 1'-0"

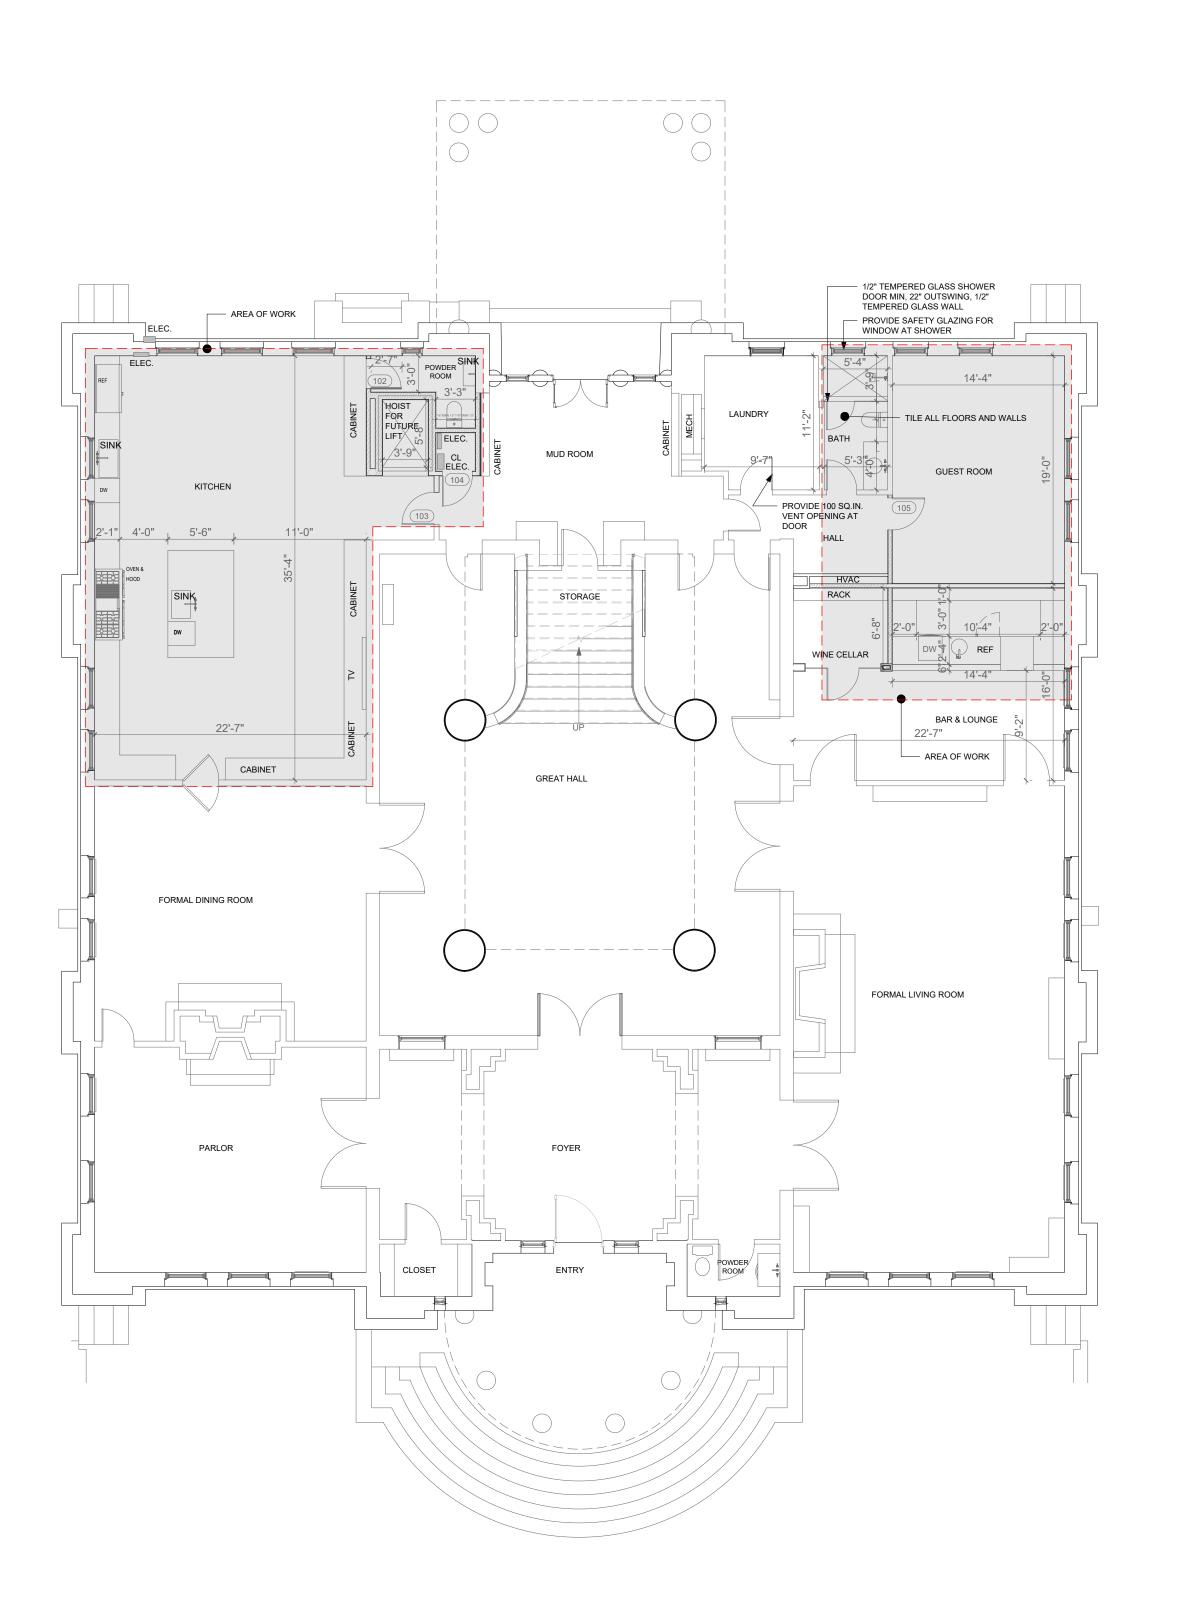

2 <u>1ST FLOOR PROPOSED</u> 1/8" = 1'-0"

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> DESIGNER & DRAFTER : SADAF DAYLAMI

PROJECT **SPRING MANSION** 

OWNER(S)

ABBAS MASH

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AREA

ORIENTATION



SHEET TITLE

MAIN 1ST FLOOR PLANS **EXISTING & PROPOSED** 

SCALE

AS INDICATED

SHEET NUMBER

WALL LEGEND

DEMOLISHED WALL **NEW WALL** 

1 HOUR RATED WALL

NOTES: ALL NEW WALLS TO MATCH EXISTING FINISH, BASEBOARD AND MOLDING

STORAGE SUN ROOM BEDROOM BEDROOM

1) 2ND FLOOR EXISTING 1/8" = 1'-0"



2 2ND FLOOR PROPOSED 1/8" = 1'-0"

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> > PROJECT


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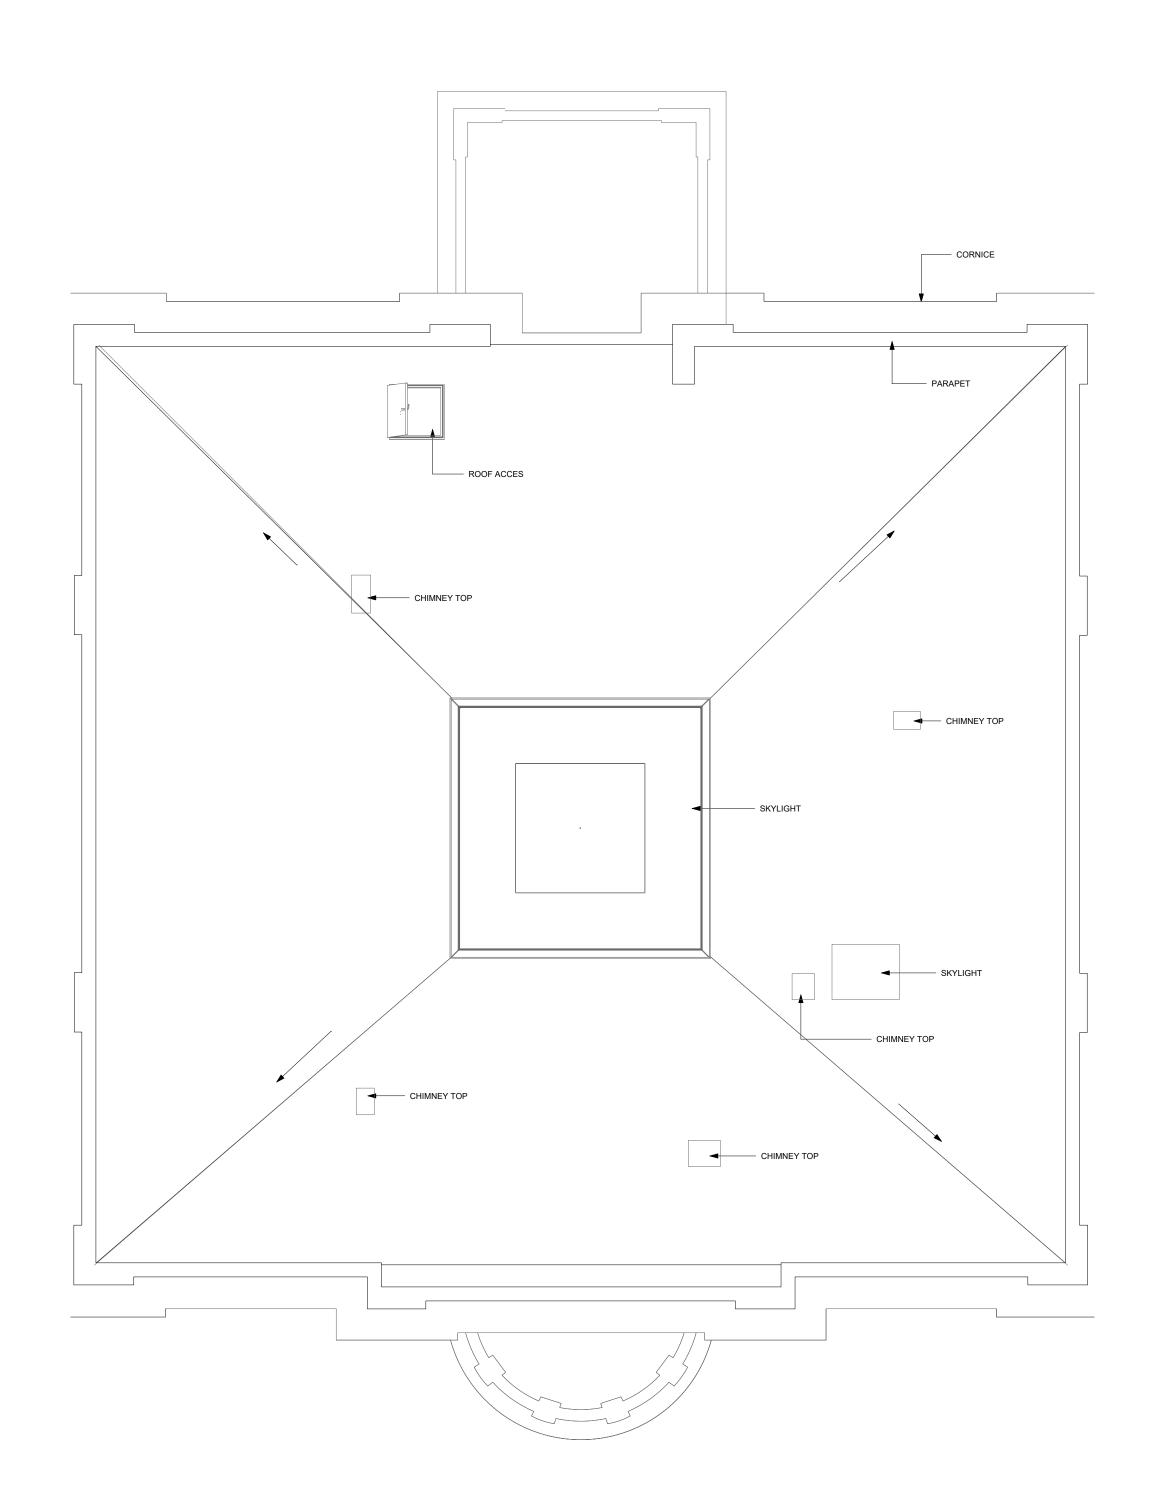
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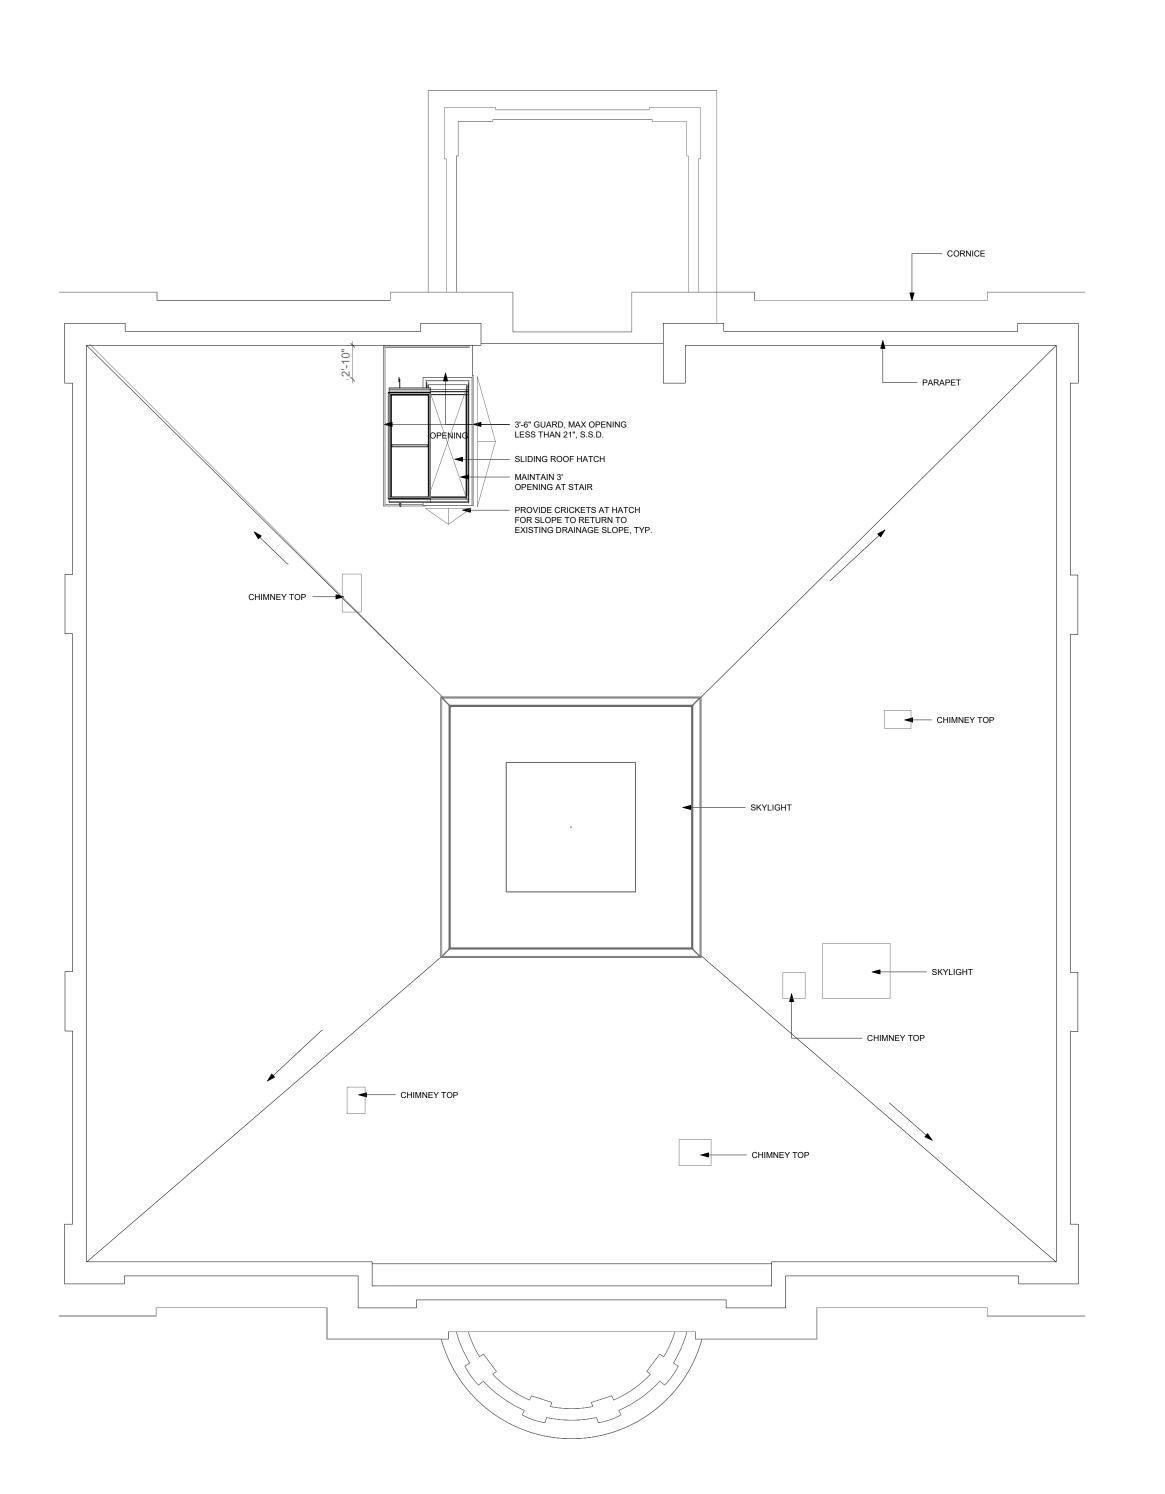
SCALE

AS INDICATED

SHEET NUMBER



ROOF PLAN EXISTING

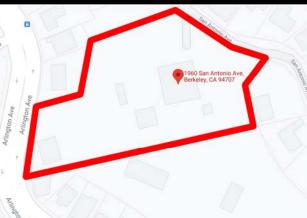

2 ROOF PLAN PROPOSED

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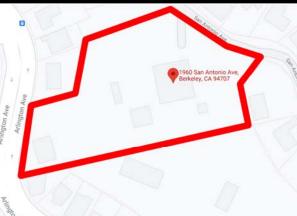
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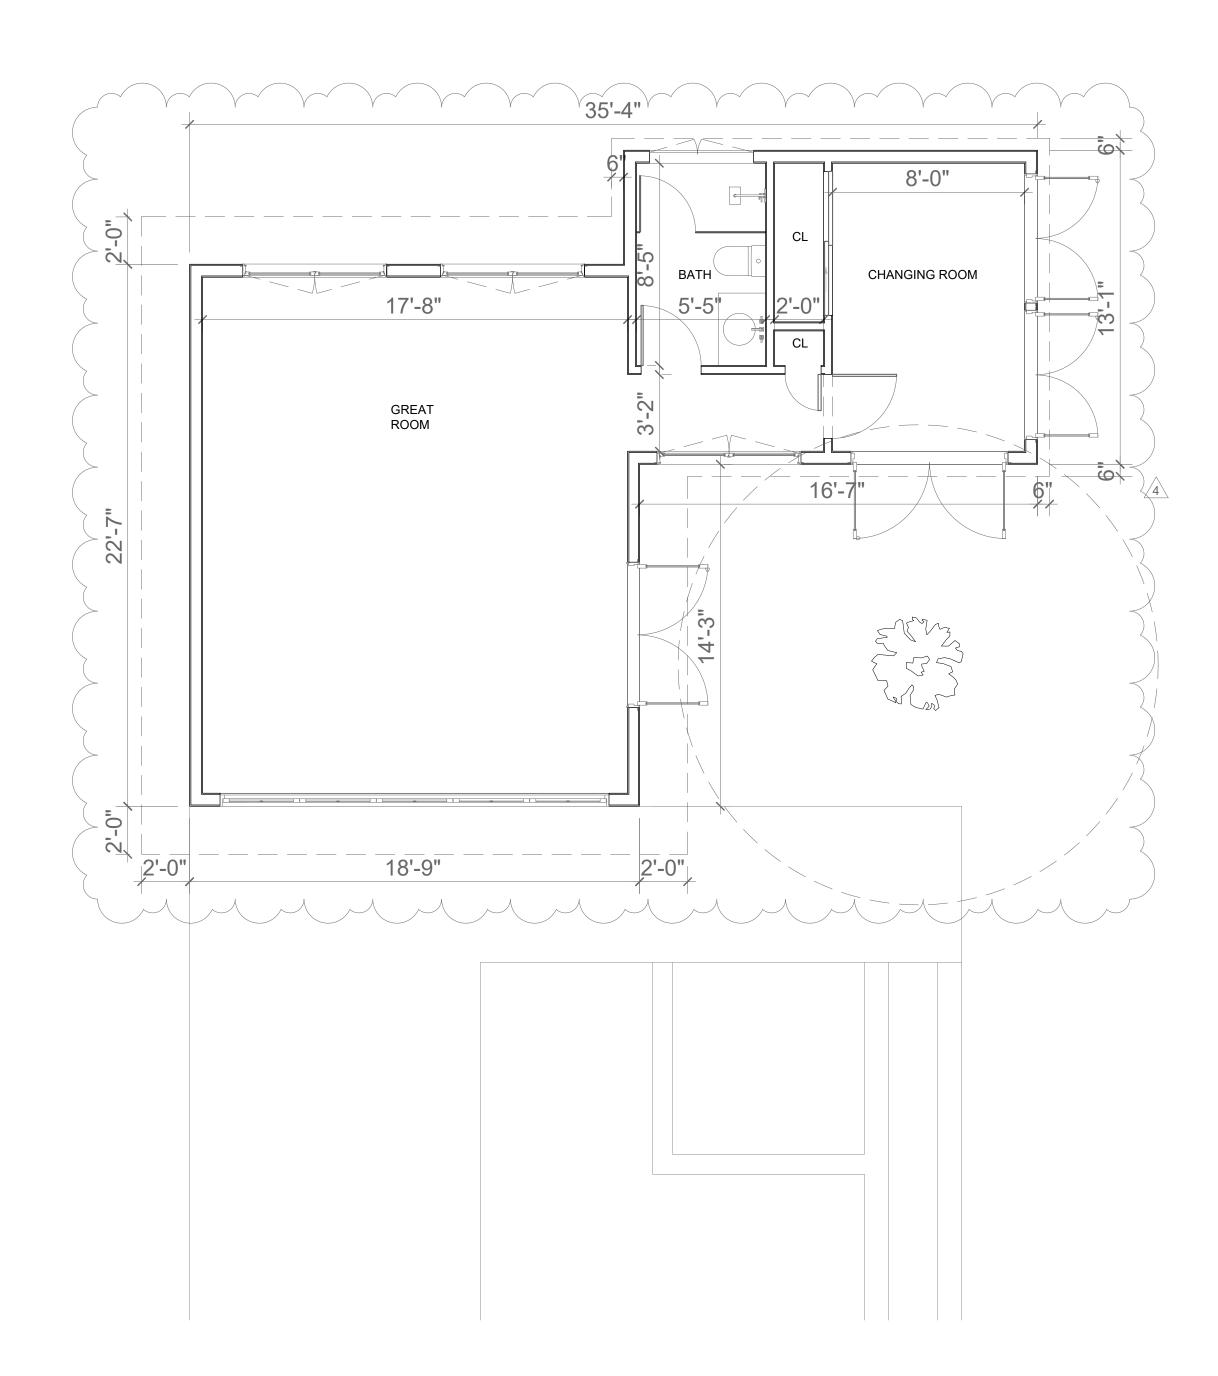
SHEET TITLE

MAIN ROOF PLANS **EXISTING & PROPOSED** 

SCALE


AS INDICATED

SHEET NUMBER



POOL HOUSE PLAN - PROPOSED

1/4" = 1'-0"

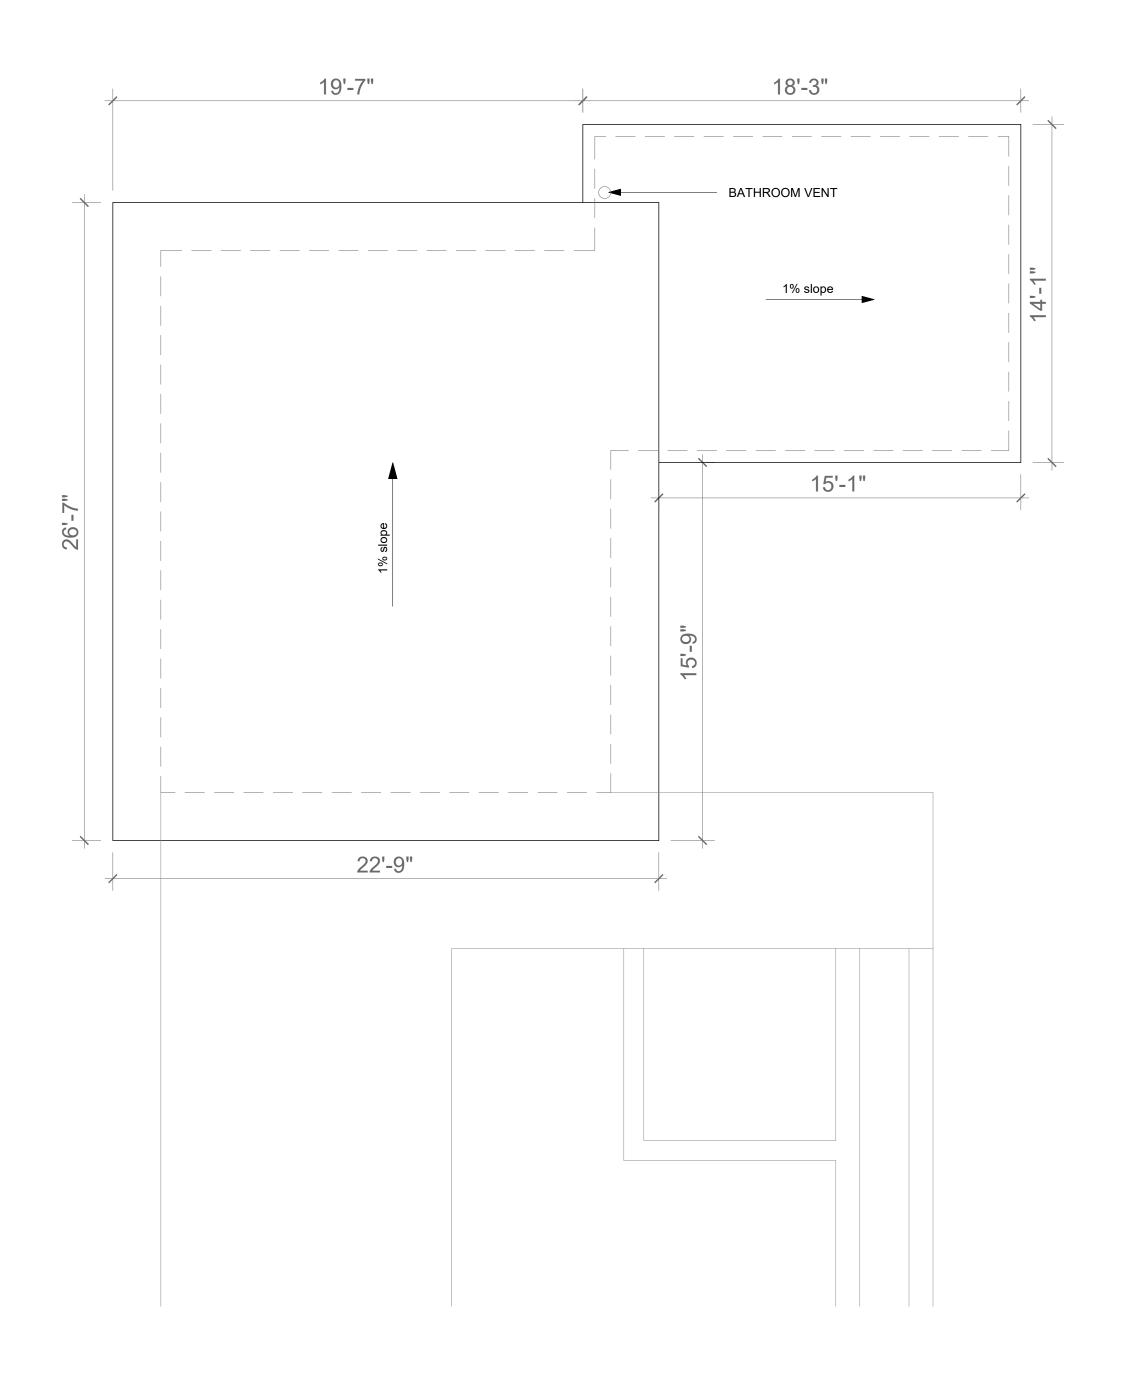

POOL HOUSE ROOF PLAN - PROPOSED

1/4" = 1'-0"

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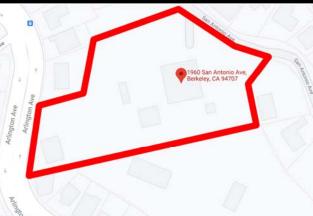
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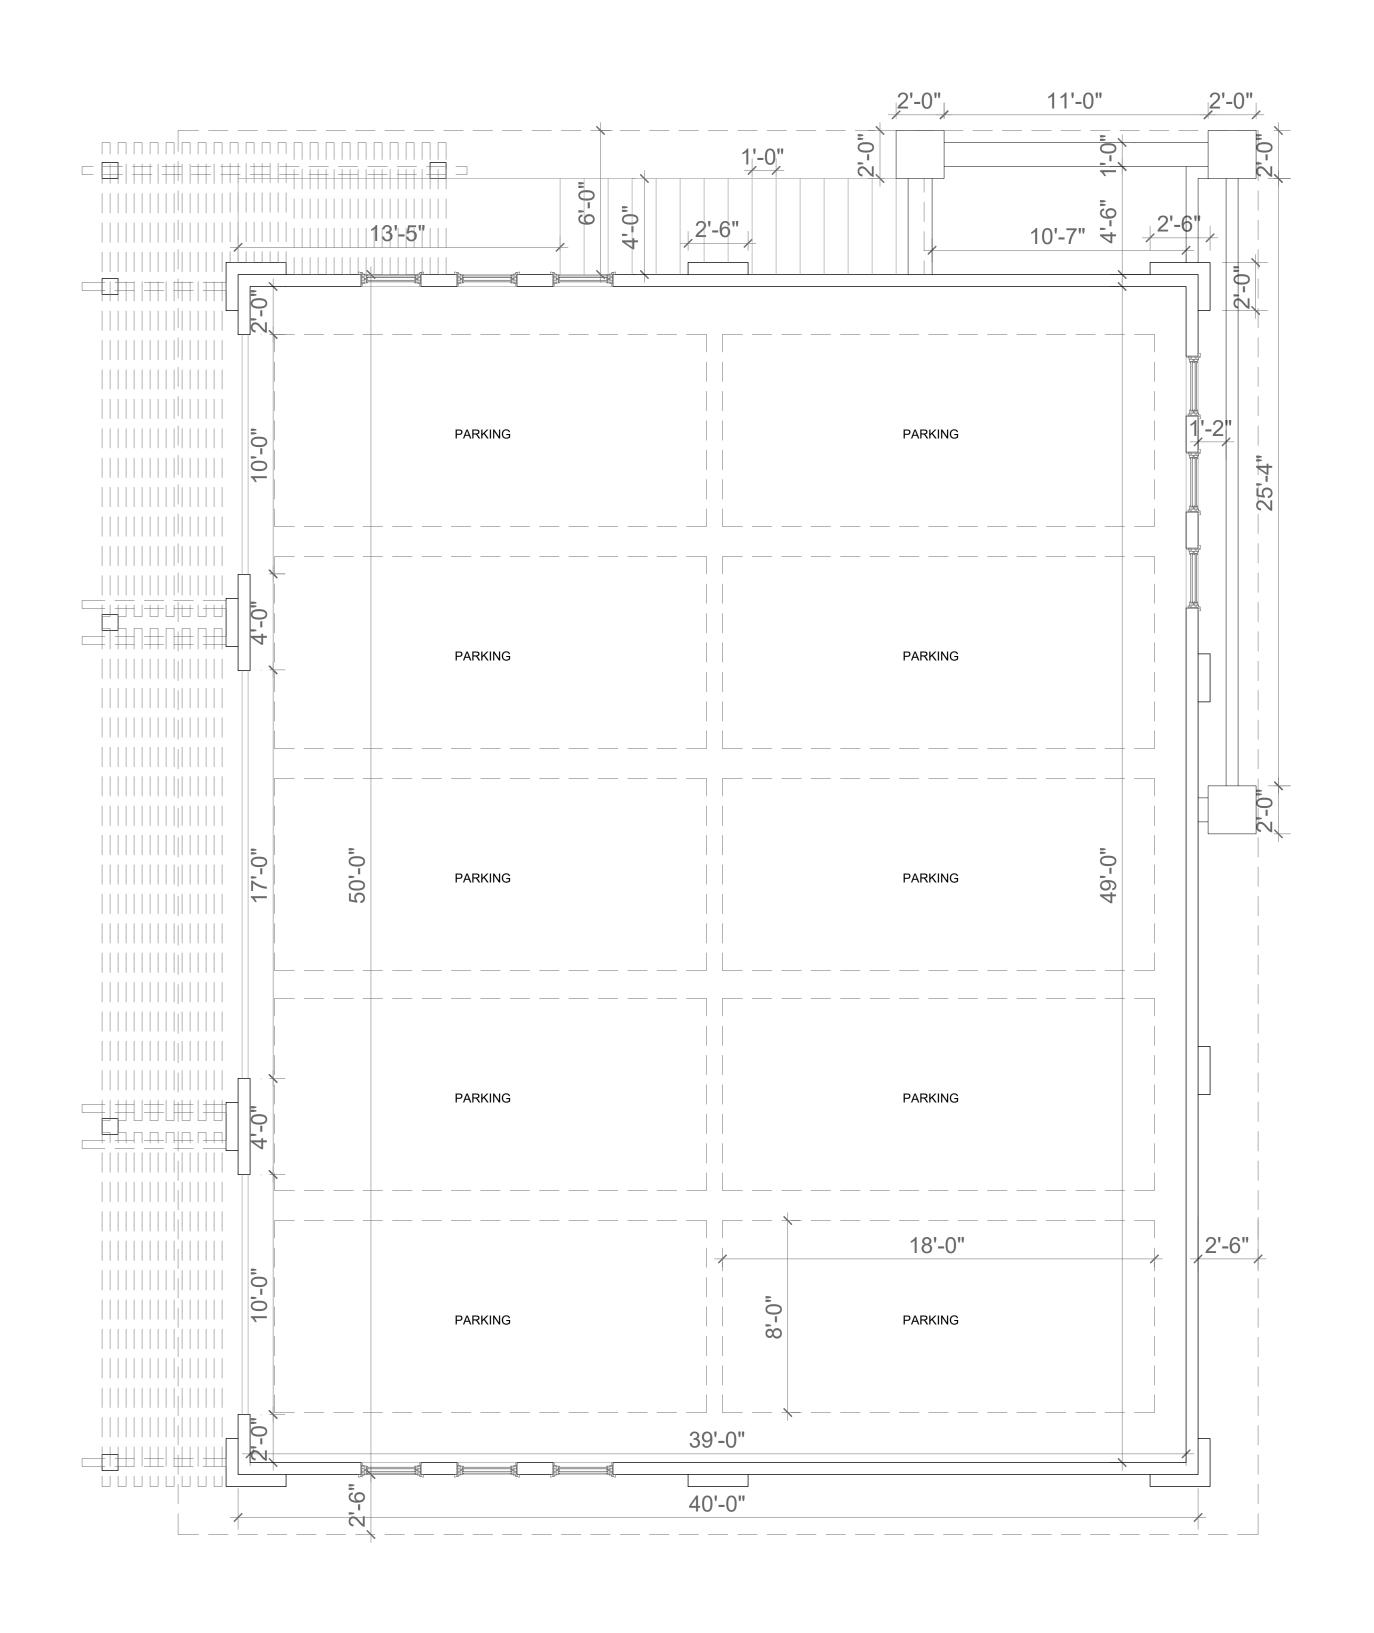
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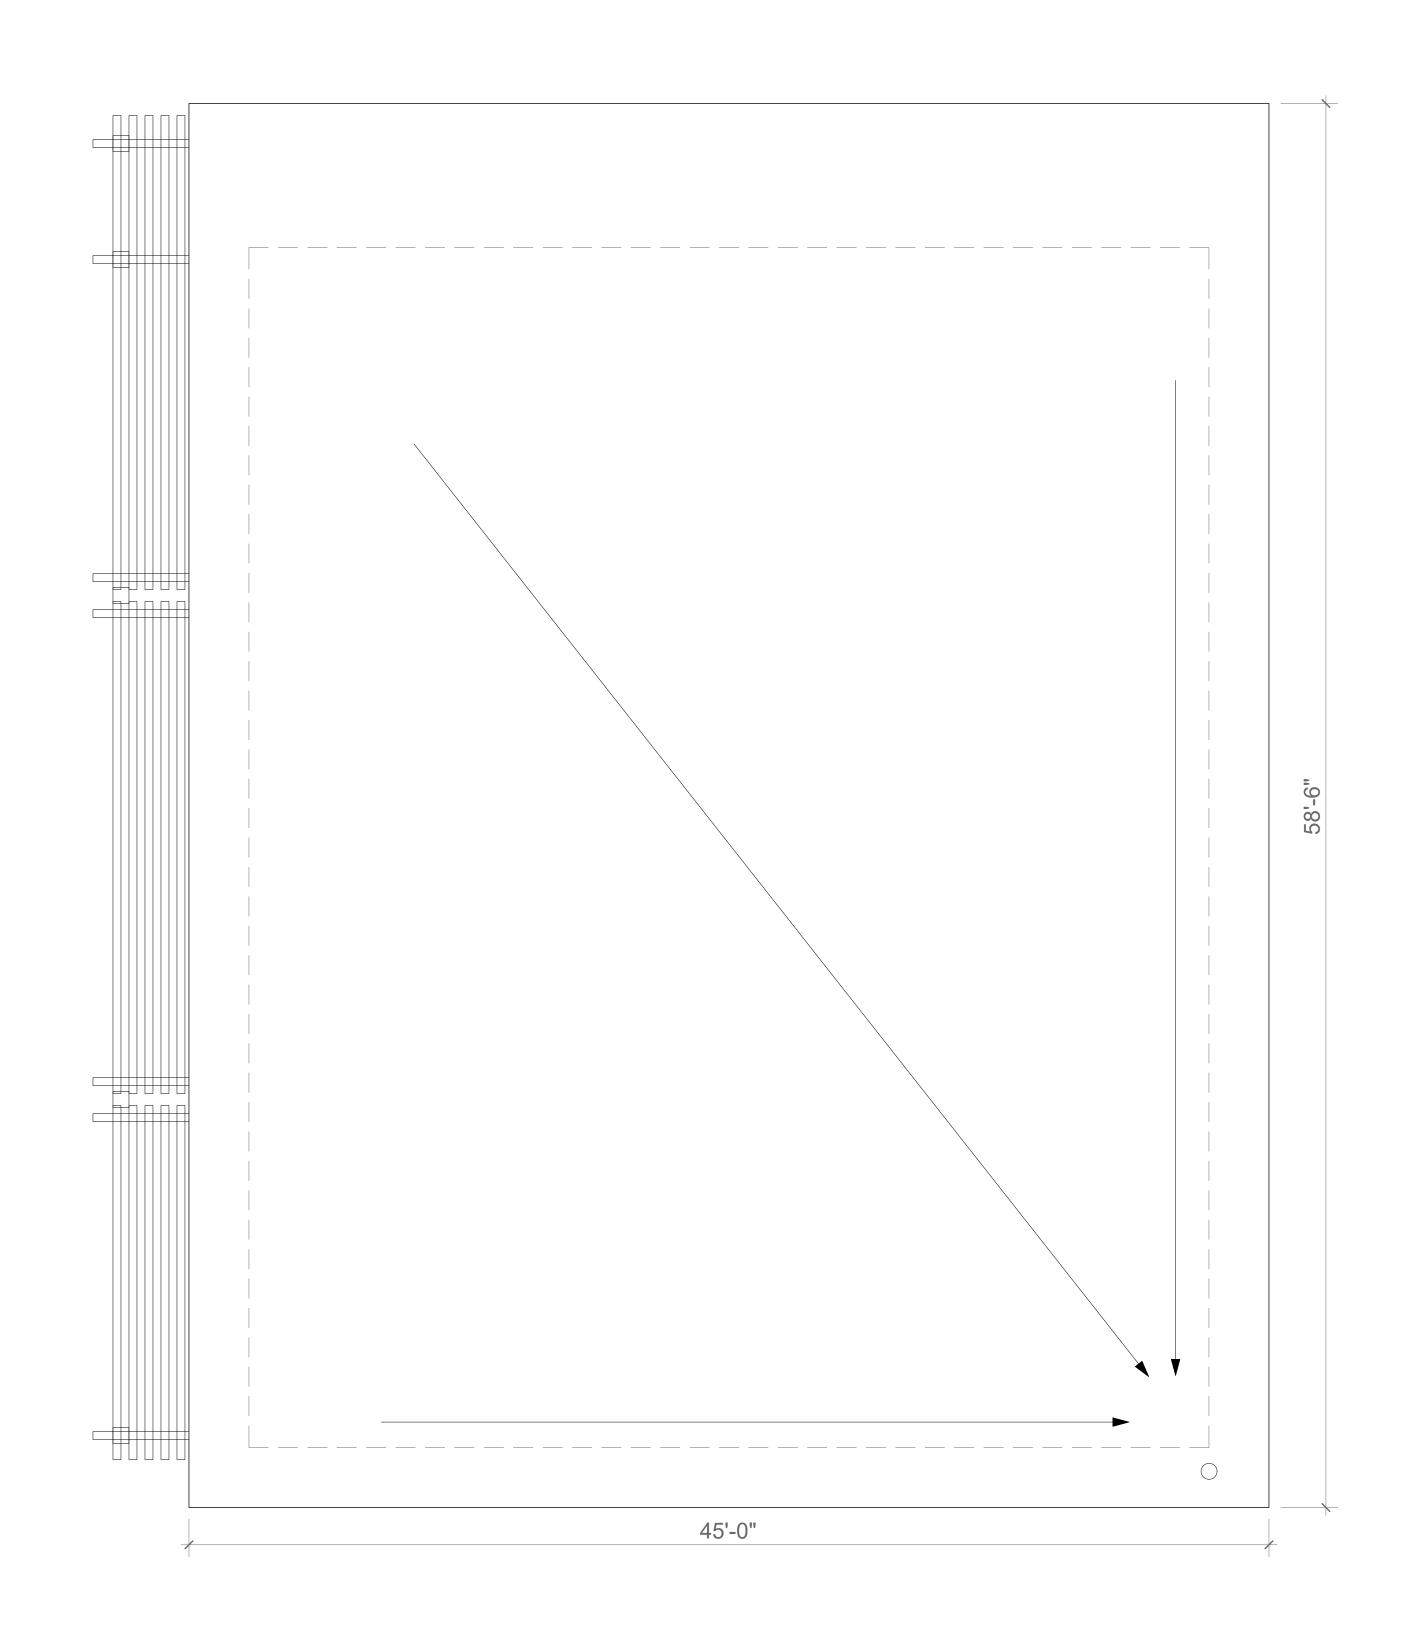
POOL HOUSE PLANS PROPOSED

SCALE

AS INDICATED

SHEET NUMBER





GARAGE PLAN - PROPOSED

1/4" = 1'-0"

GARAGE ROOF PLAN - PROPOSED 1/4" = 1'-0"

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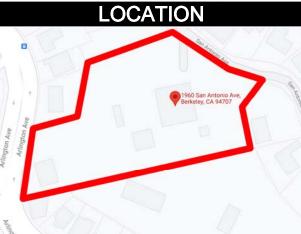
PROJECT

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ORIENTATION



SHEET TITLE

**GARAGE PLANS** PROPOSED

SCALE


SHEET NUMBER

AS INDICATED

A105A

PAYMUN BUILDING &

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WALL LEGEND

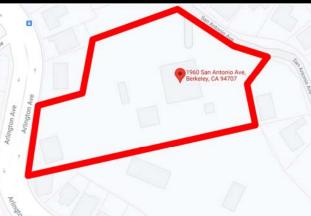DEMOLISHED WALL

EXISTING WALL

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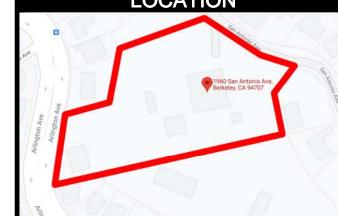
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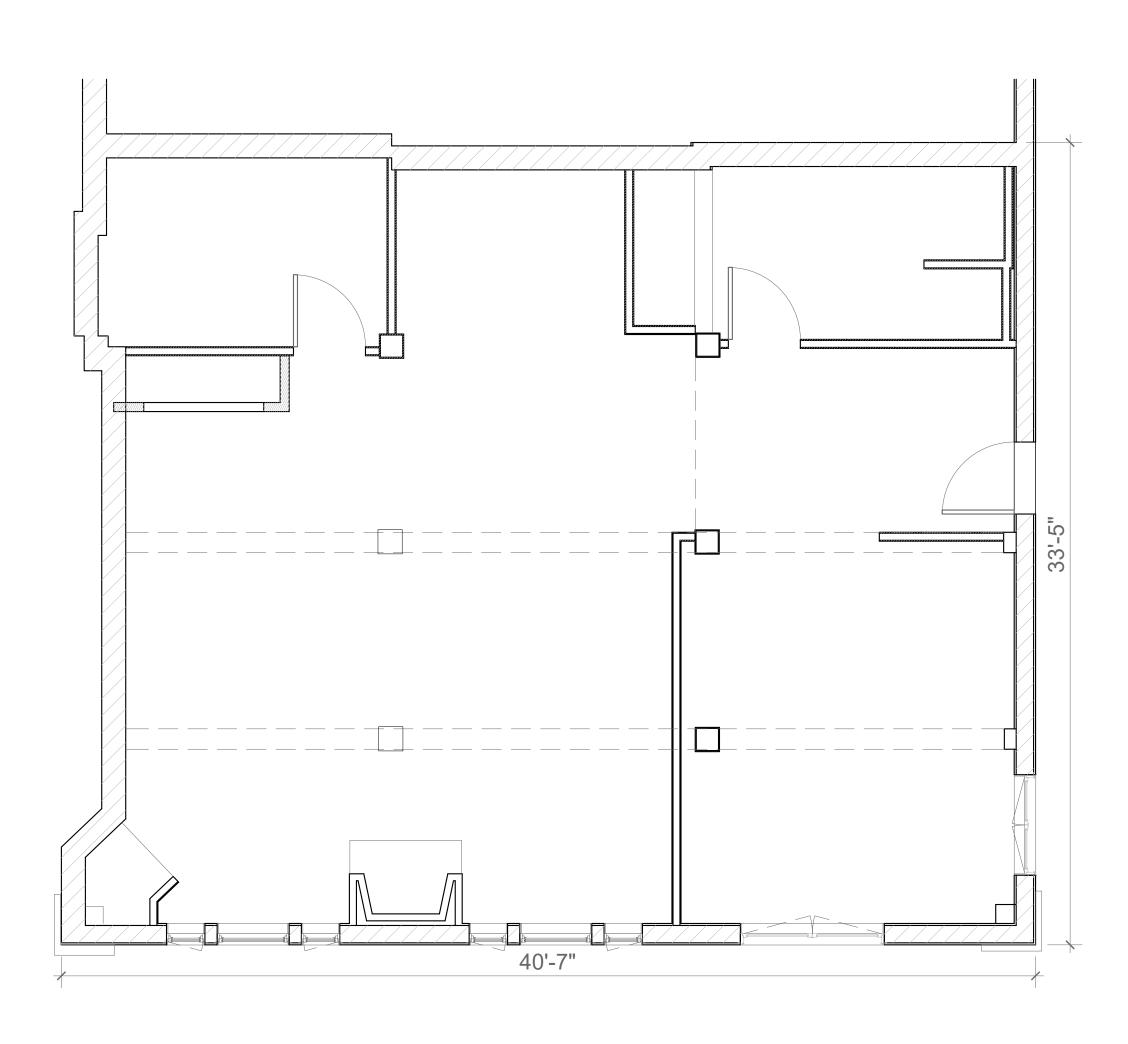
SHEET TITLE
GAMEROOM

PLANS & ELEVATIONS
EXISTING & PROPOSED

SCALE AS INDICATED


SHEET NUMBER

A107




GAME ROOM - EXISTING & DEMOLITION

1/4" = 1'-0"

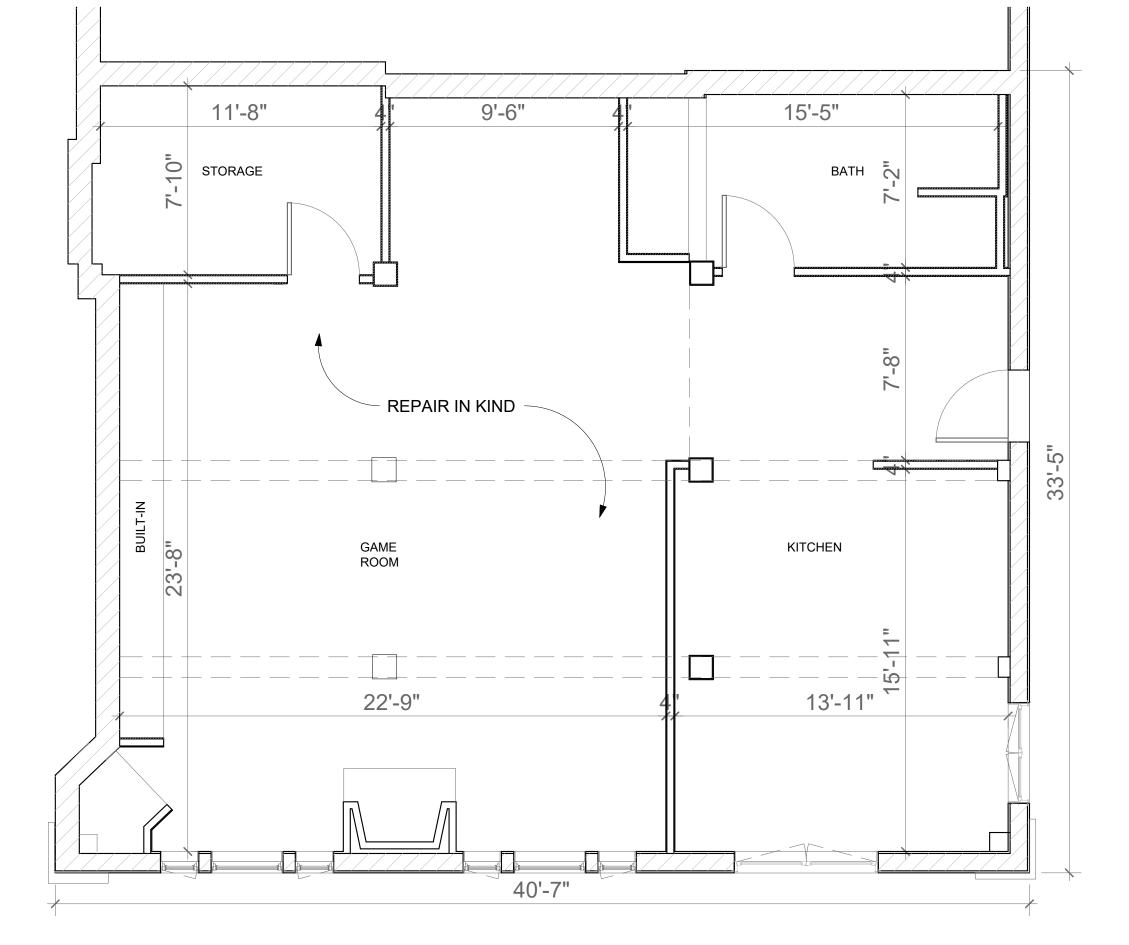


2 GAME ROOM - PROPOSED

1/4" = 1'-0"

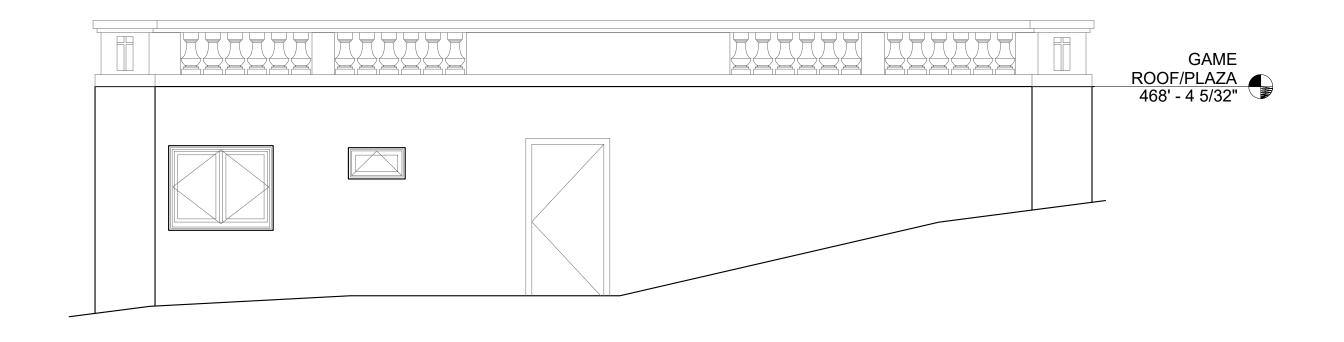


GAME ROOM - SOUTH ELEVATION

1/4" = 1'-0"

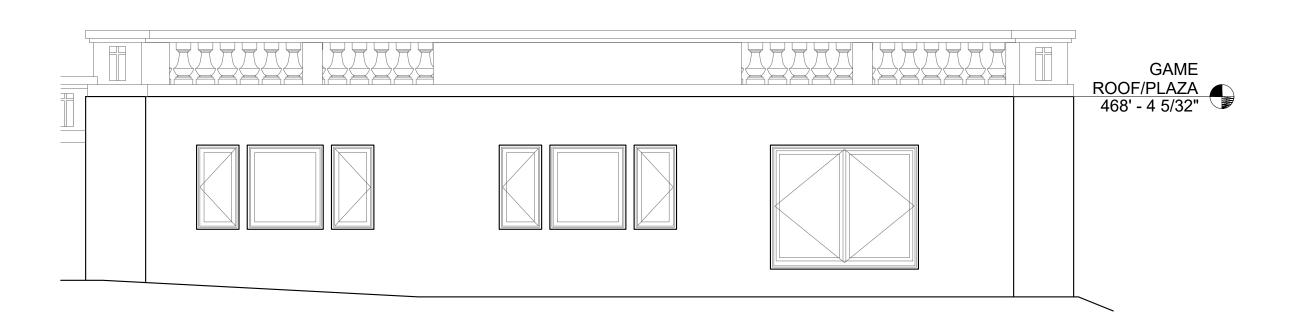


GAME ROOM - WEST ELEVATION

1/4" = 1'-0"

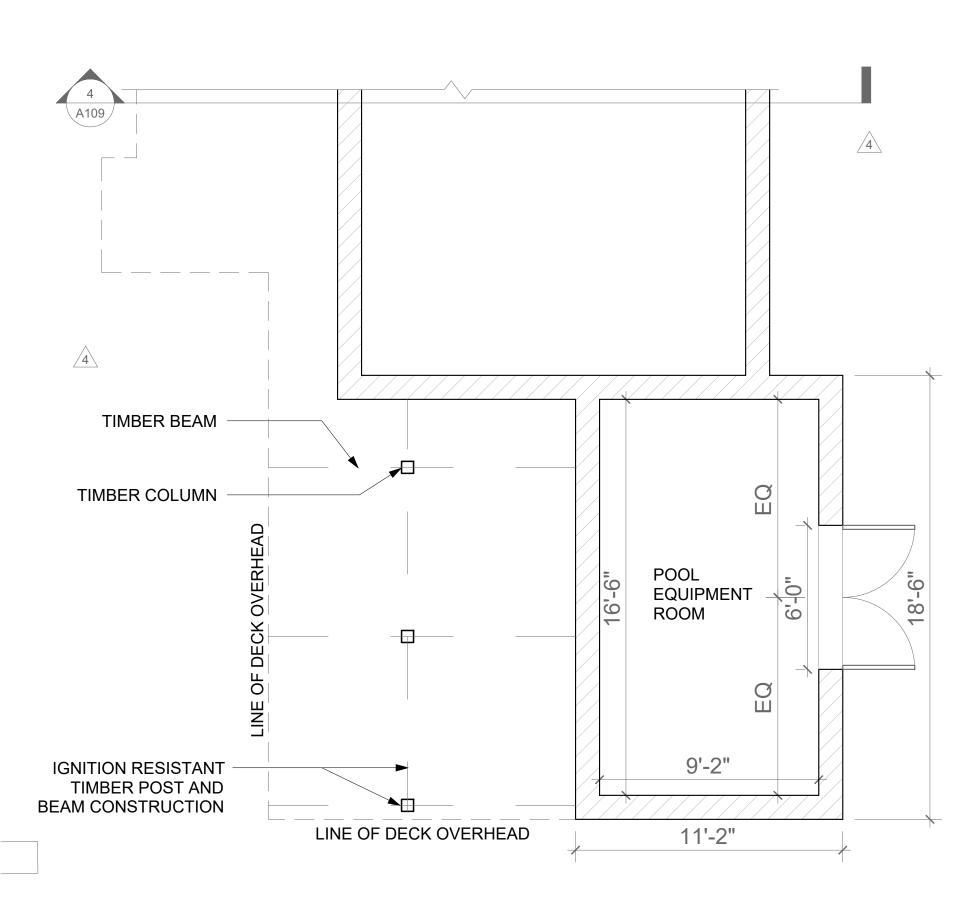


POOL EQUIPMENT ROOM
1/4" = 1'-0"

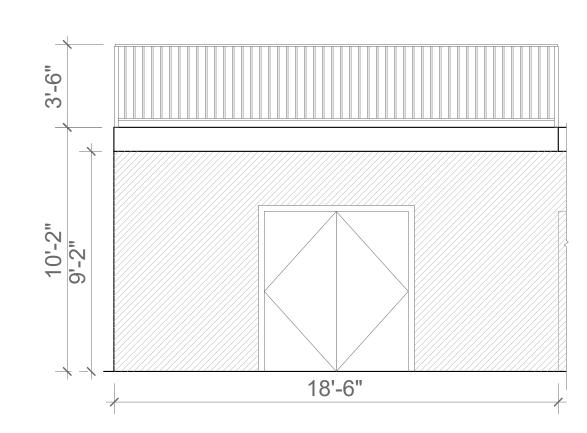


POOL EQUIPMENT - SOUTH ELEVATION

1/4" = 1'-0"

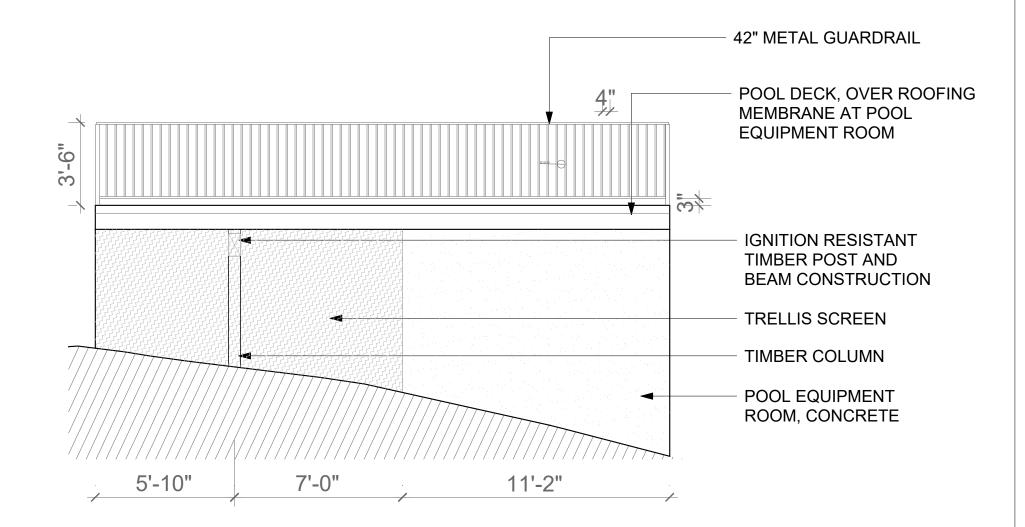

POOL EQUIPMENT - WEST ELEVATION

1/4" = 1'-0"

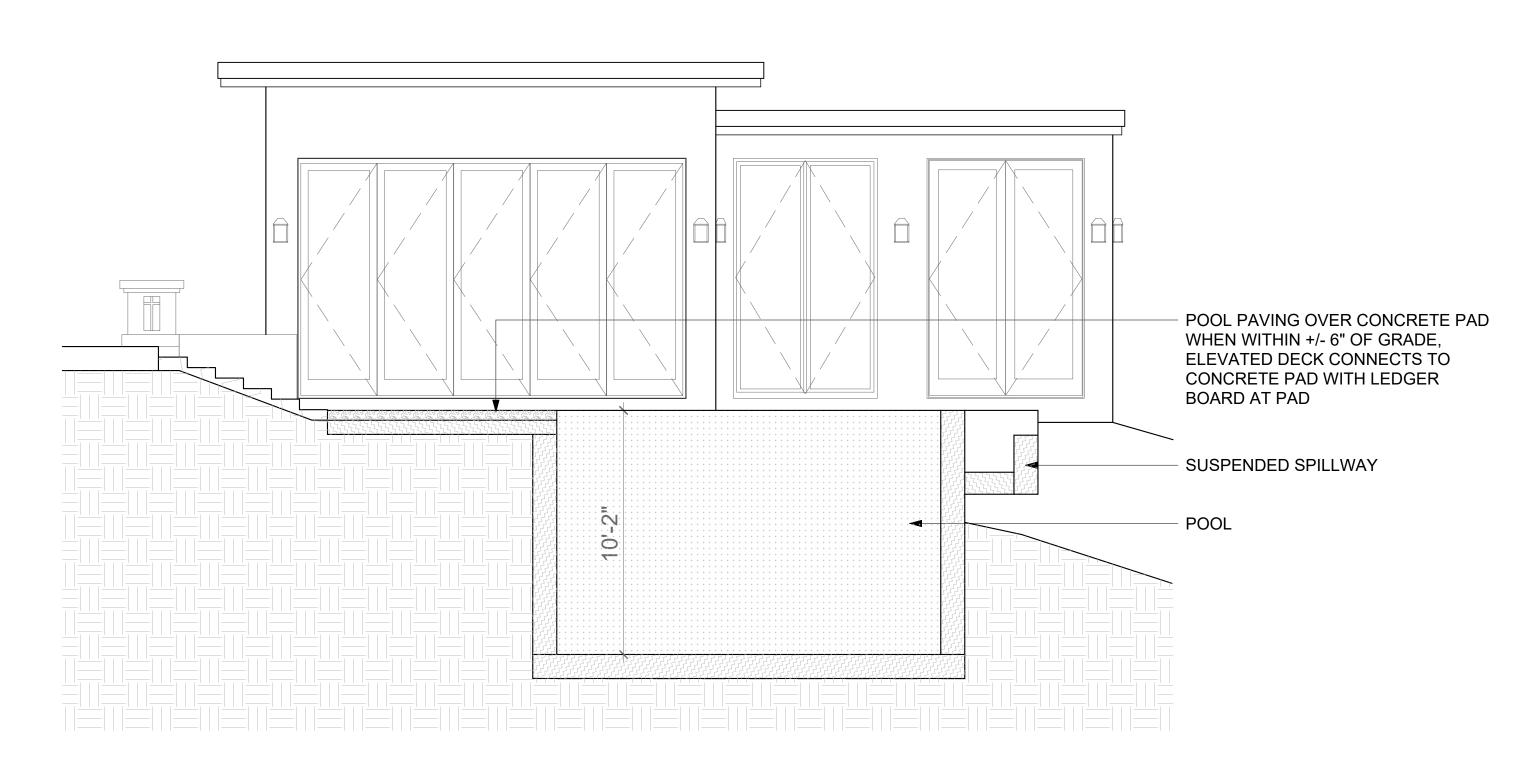

SECTION AT TERRACE STAIRS TO POOL DECK

1/4" = 1'-0"

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PROJECT


**SPRING MANSION** 

OWNER(S)

ABBAS MASH

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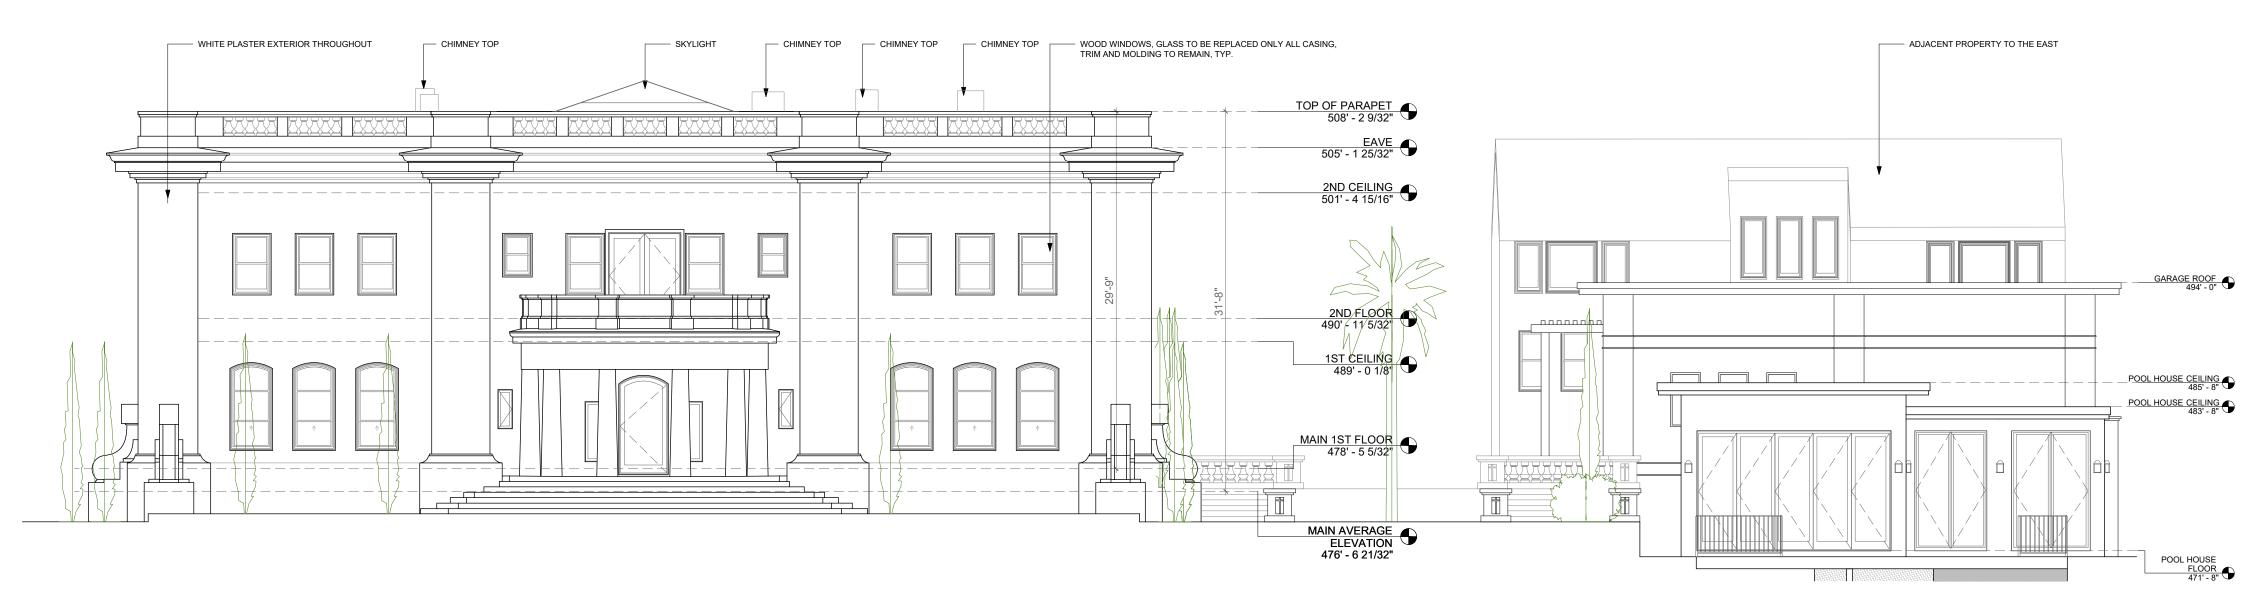
SHEET TITLE

POOL EQUIPMENT ROOM PLAN, ELEVATION & SECTION

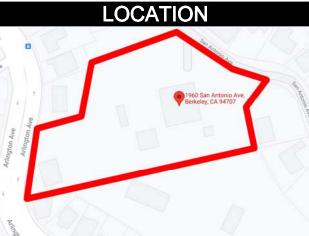
SCALE

AS INDICATED

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1 WEST ELEVATION - PROPOSED 1/8" = 1'-0"



WEST ELEVATION - EXISTING
1/8" = 1'-0"
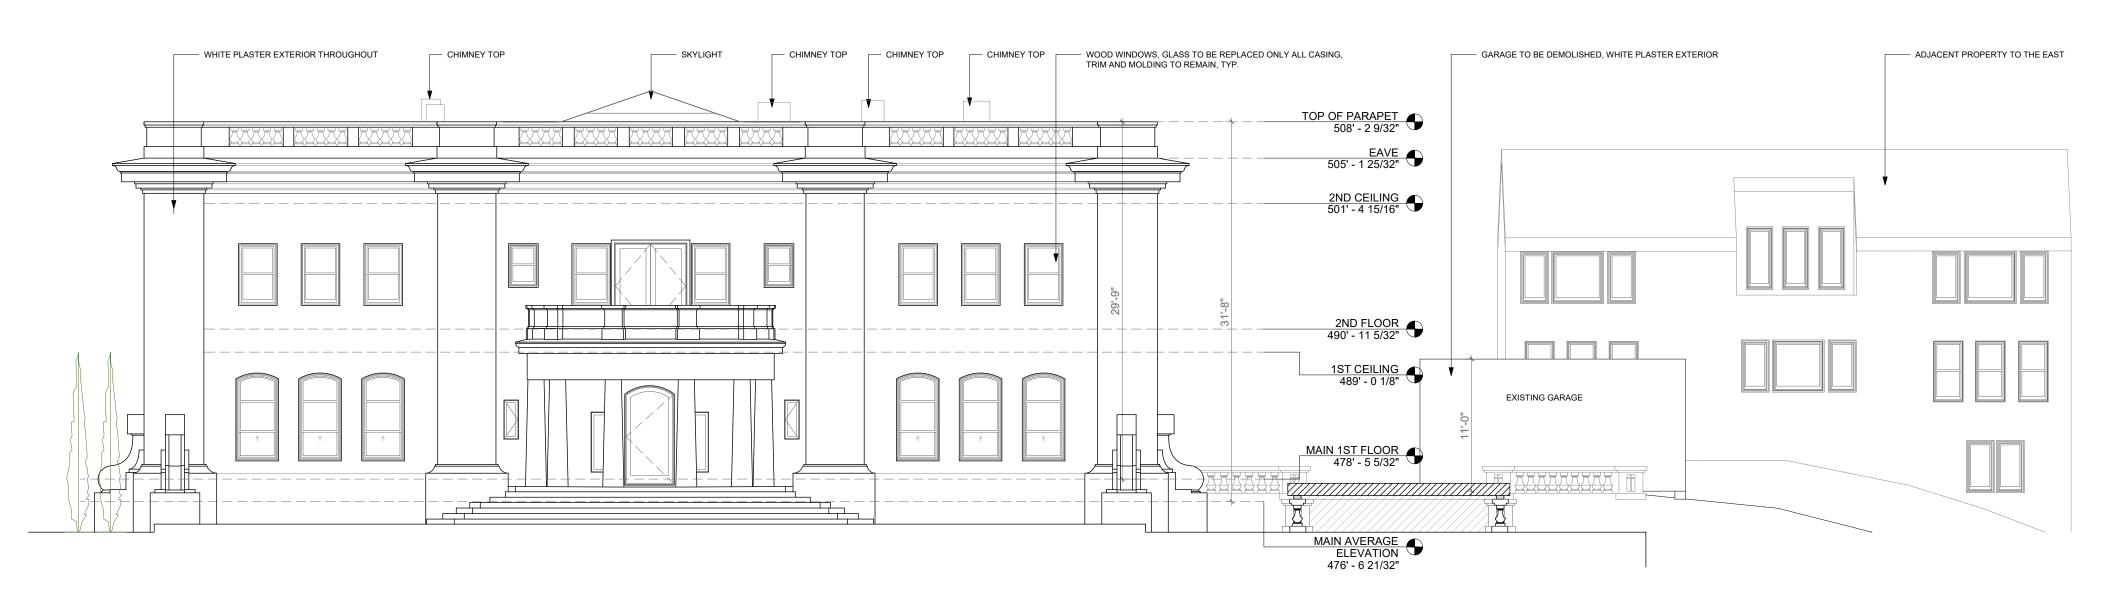
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Ben@paymun.com

LEAD DESIGN CONSULTANT

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AREA

ORIENTATION

SHEET TITLE

MAIN ELEVATIONS WEST EXISTING & PROPOSED


SCALE

AS INDICATED

SHEET NUMBER



1 EAST ELEVATION - PROPOSED 1/8" = 1'-0"

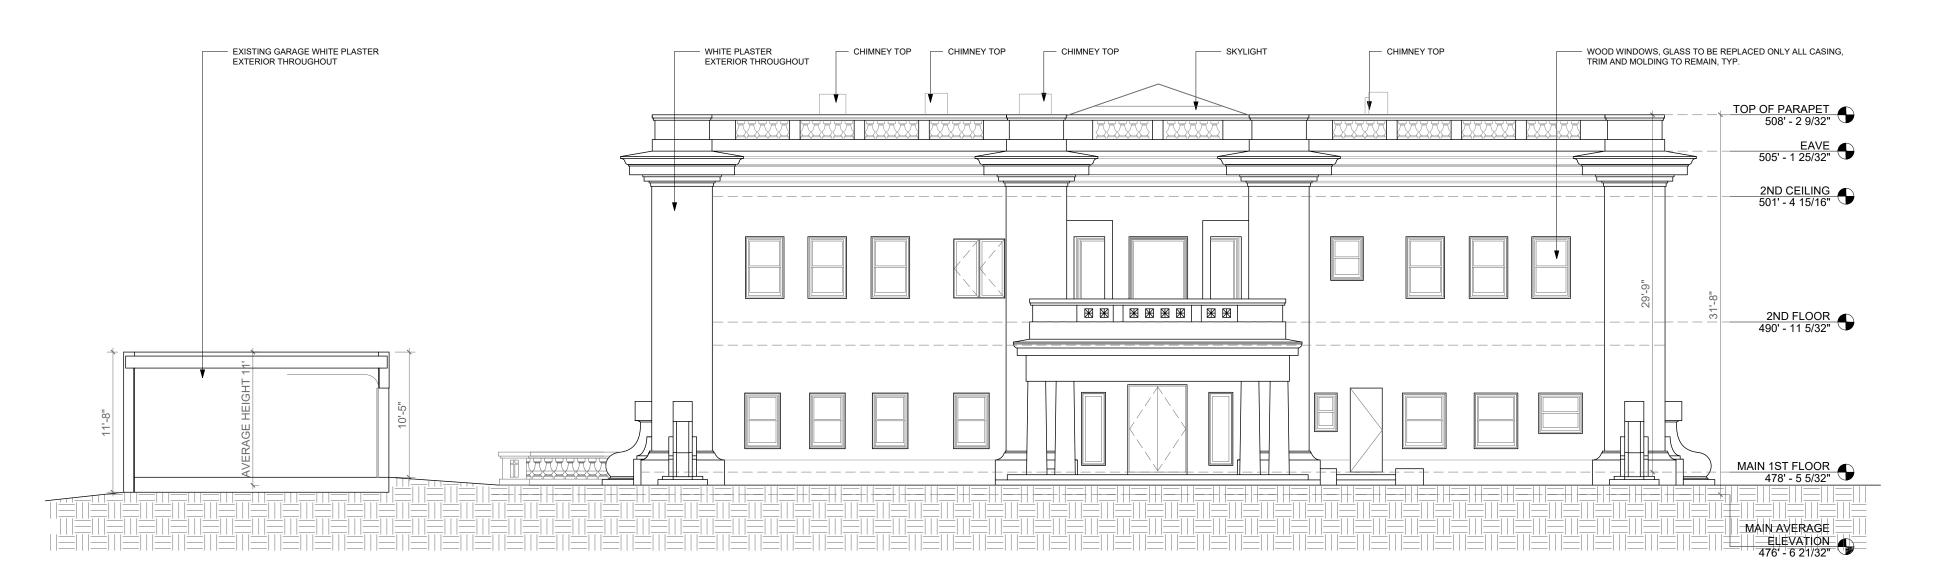

2 EAST ELEVATION - EXISTING 1/8" = 1'-0" PAYMUN

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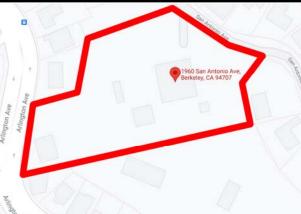
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NOTES

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LOCATION



ADDRESS

1960 SAN ANTONIO AVENUE BERKELEY, CA 94707

AREA

ORIENTATION


SHEET TITLE

MAIN ELEVATIONS EAST EXISTING & PROPOSED


SCALE

AS INDICATED

SHEET NUMBER

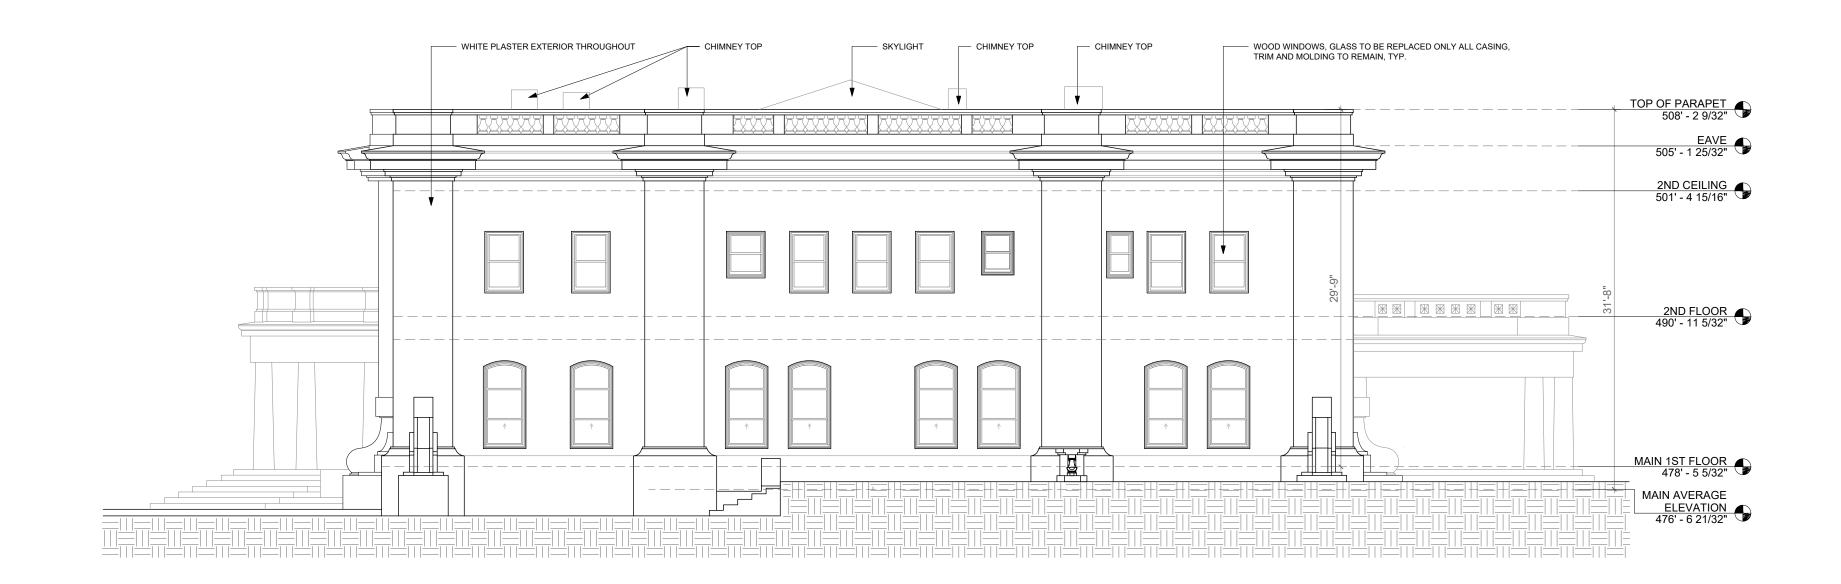

1 NORTH ELEVATION - EXISTING
1/8" = 1'-0"

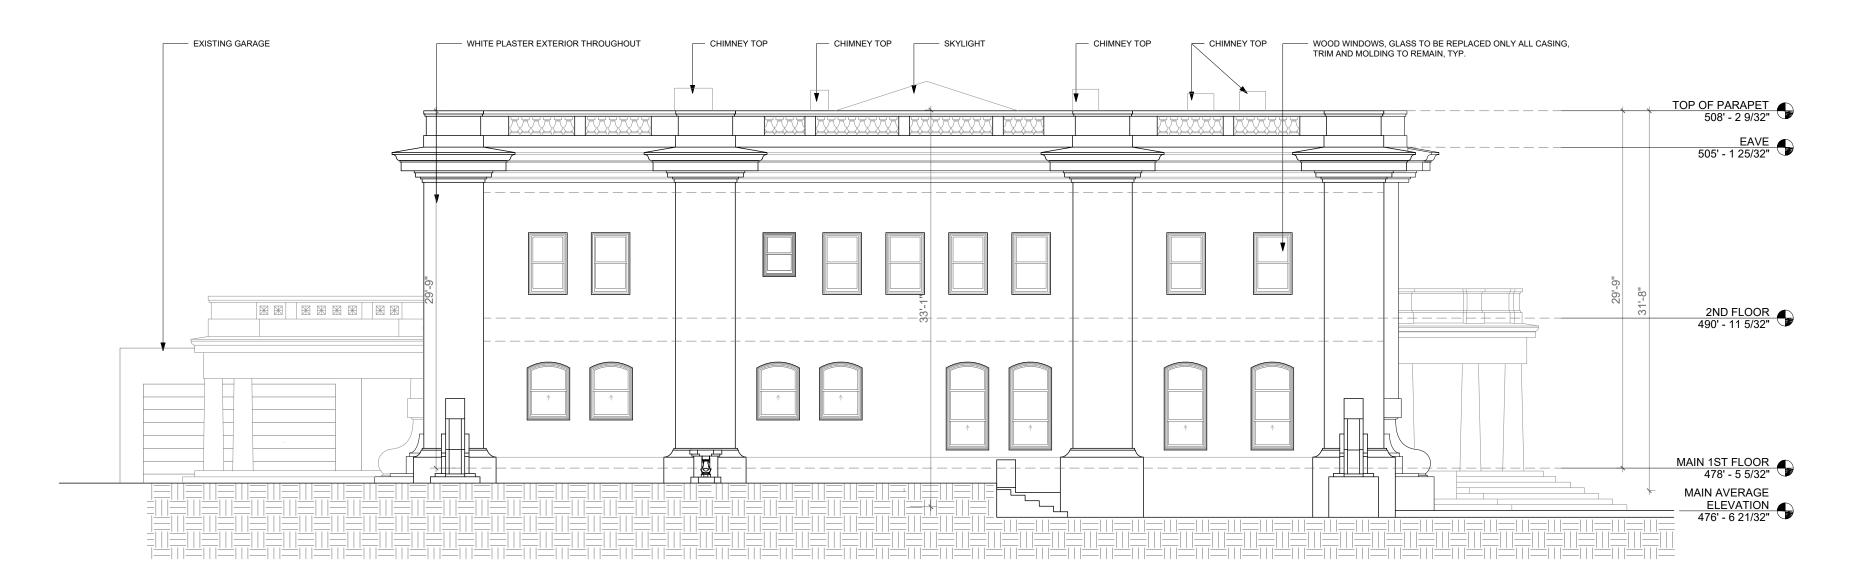

2 SOUTH ELEVATION - EXISTING
1/8" = 1'-0"

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40040440

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LOCATION



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1960 SAN ANTONIO AVENUE BERKELEY, CA 94707

AREA

ORIENTATION


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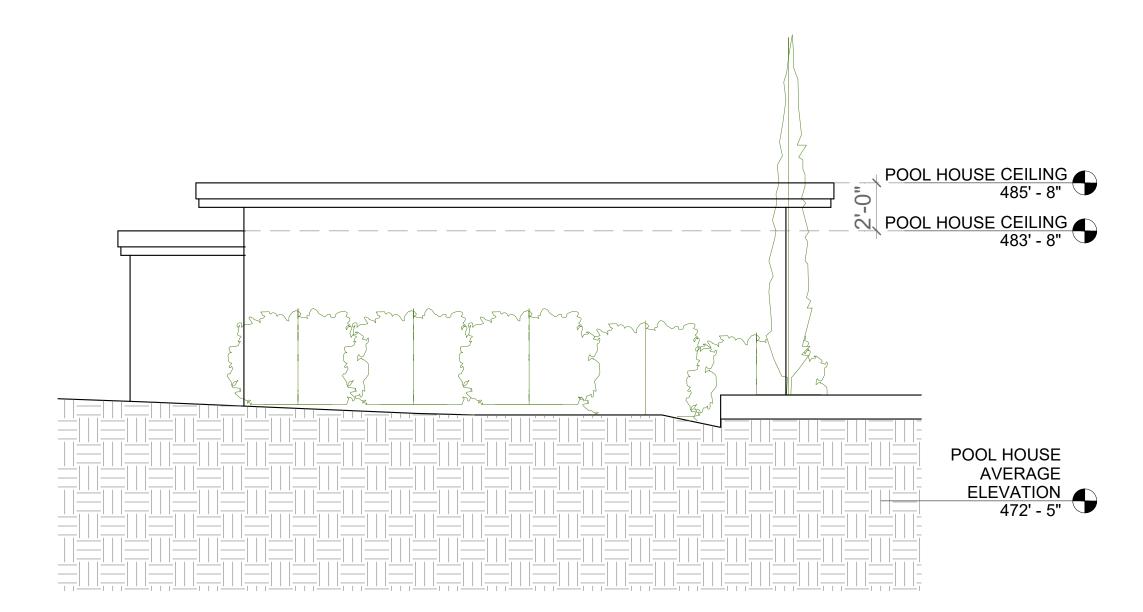
MAIN ELEVATIONS NORTH & SOUTH - EXISTING

SCALE


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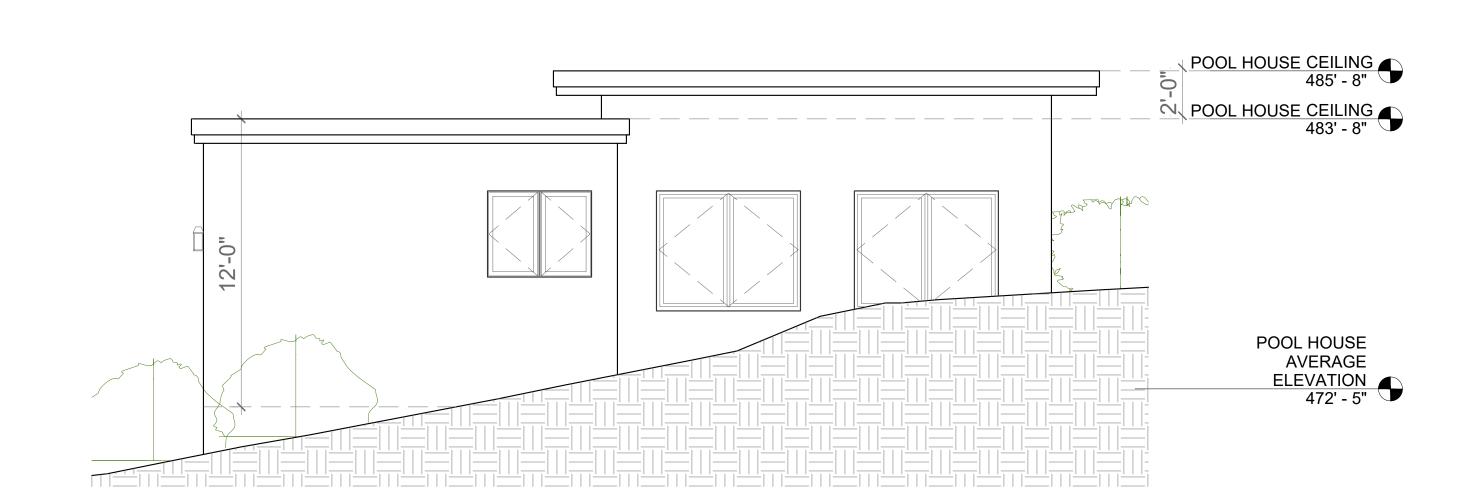
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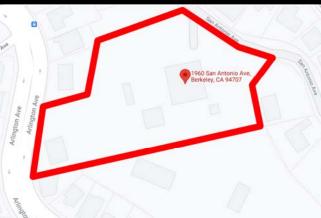
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ORIENTATION


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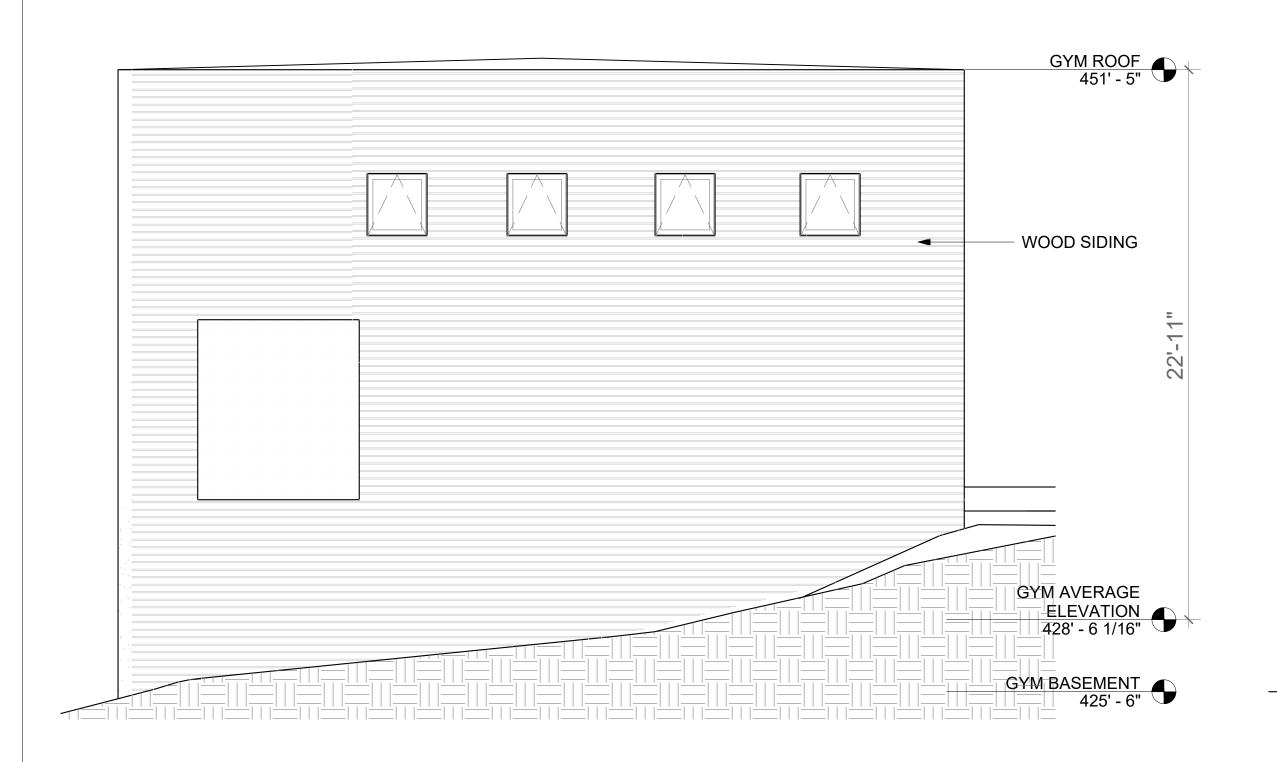
POOL HOUSE ELEVATION


SCALE

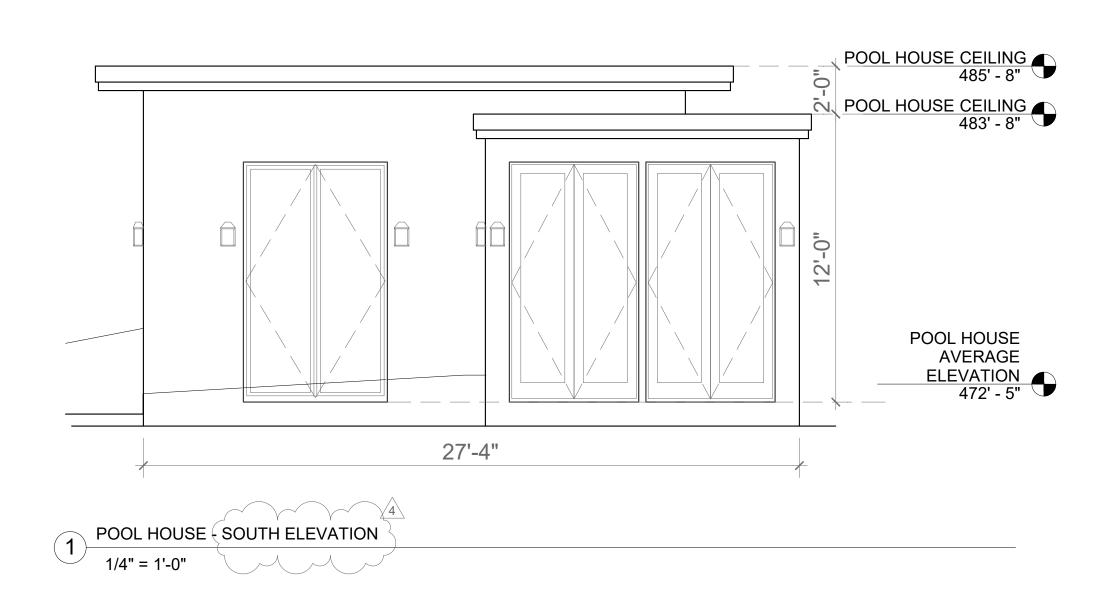AS INDICATED

SHEET NUMBER

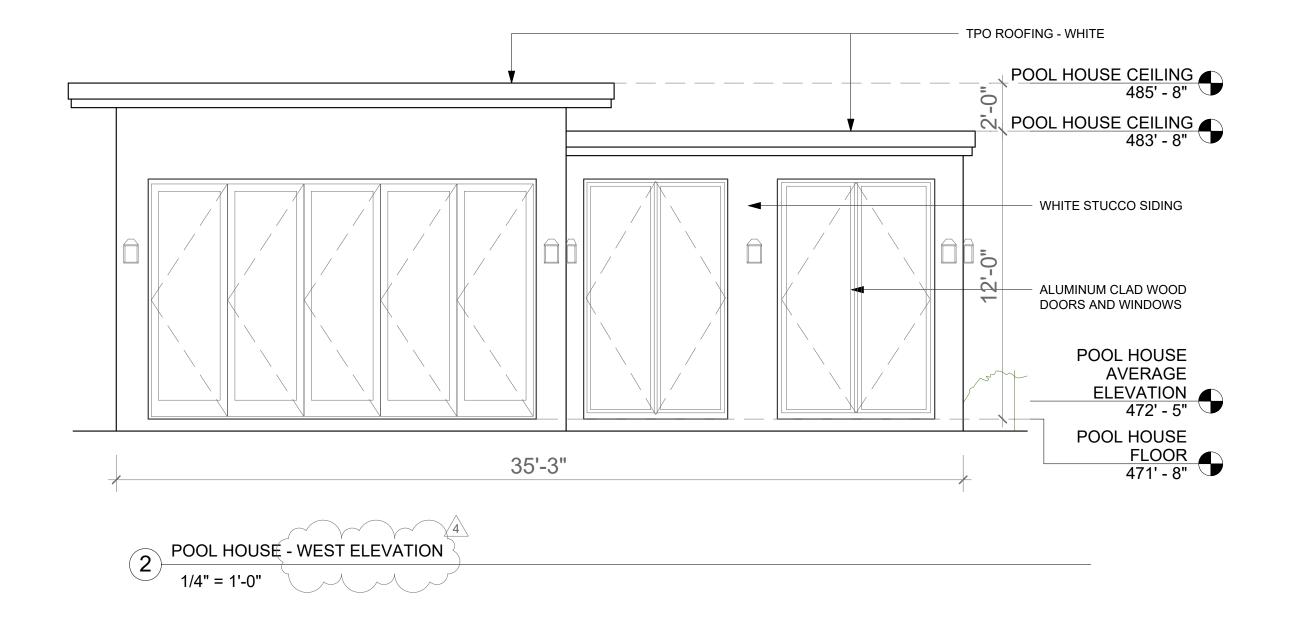


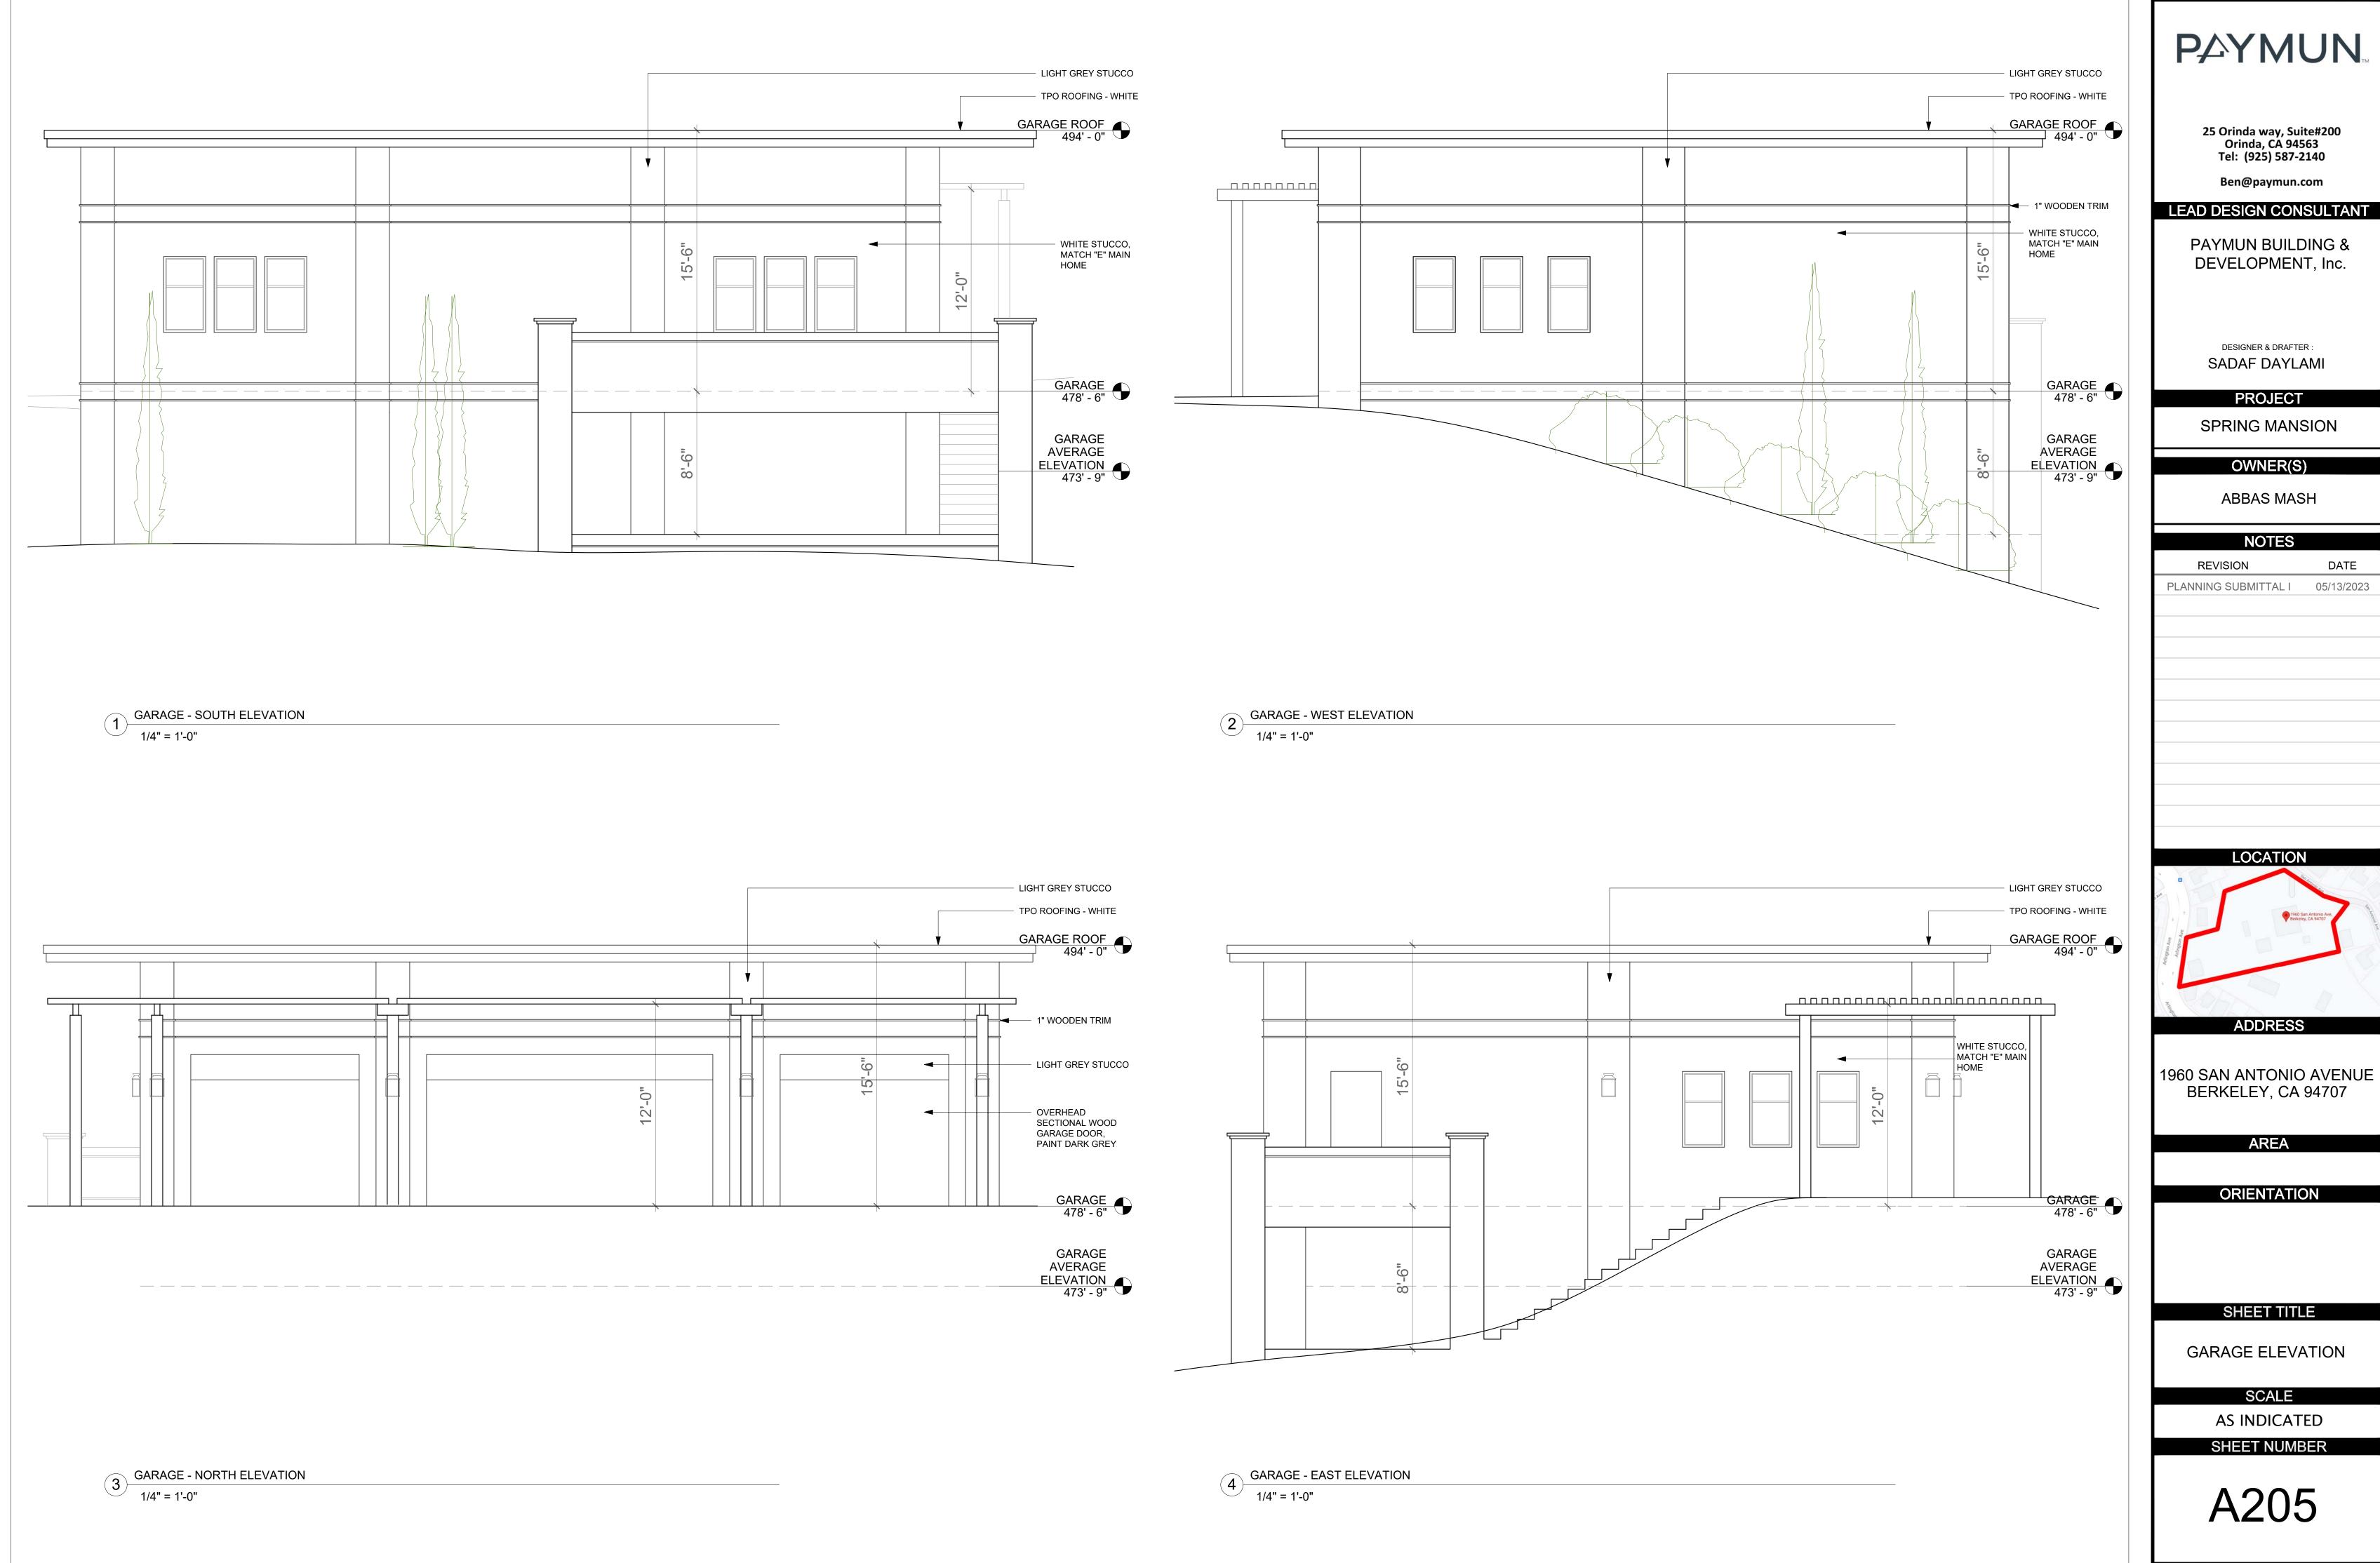

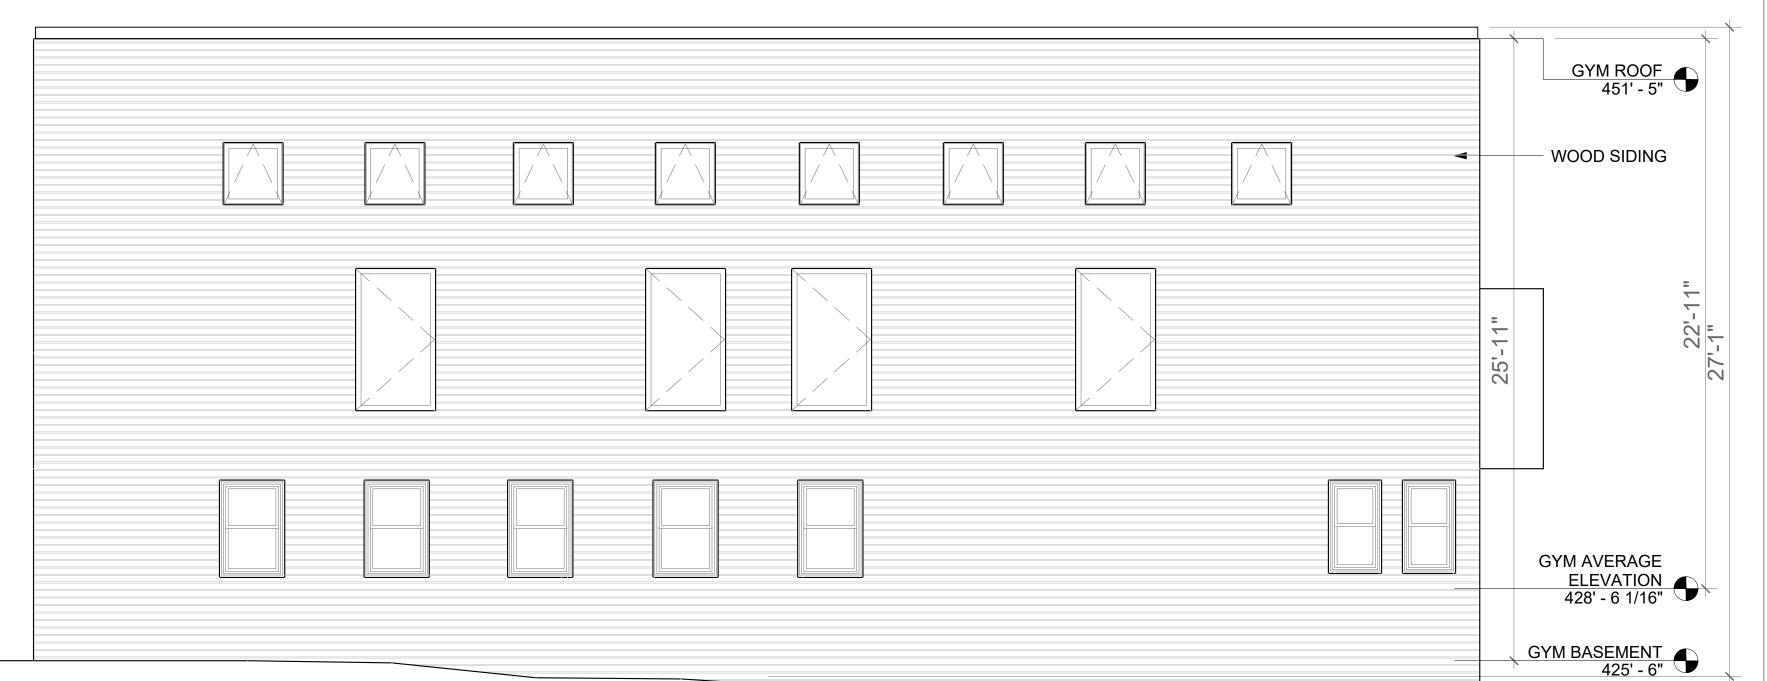

GYMNASIUM - SOUTH ELEVATION

GYMNASIUM - WEST ELEVATION 1/4" = 1'-0"

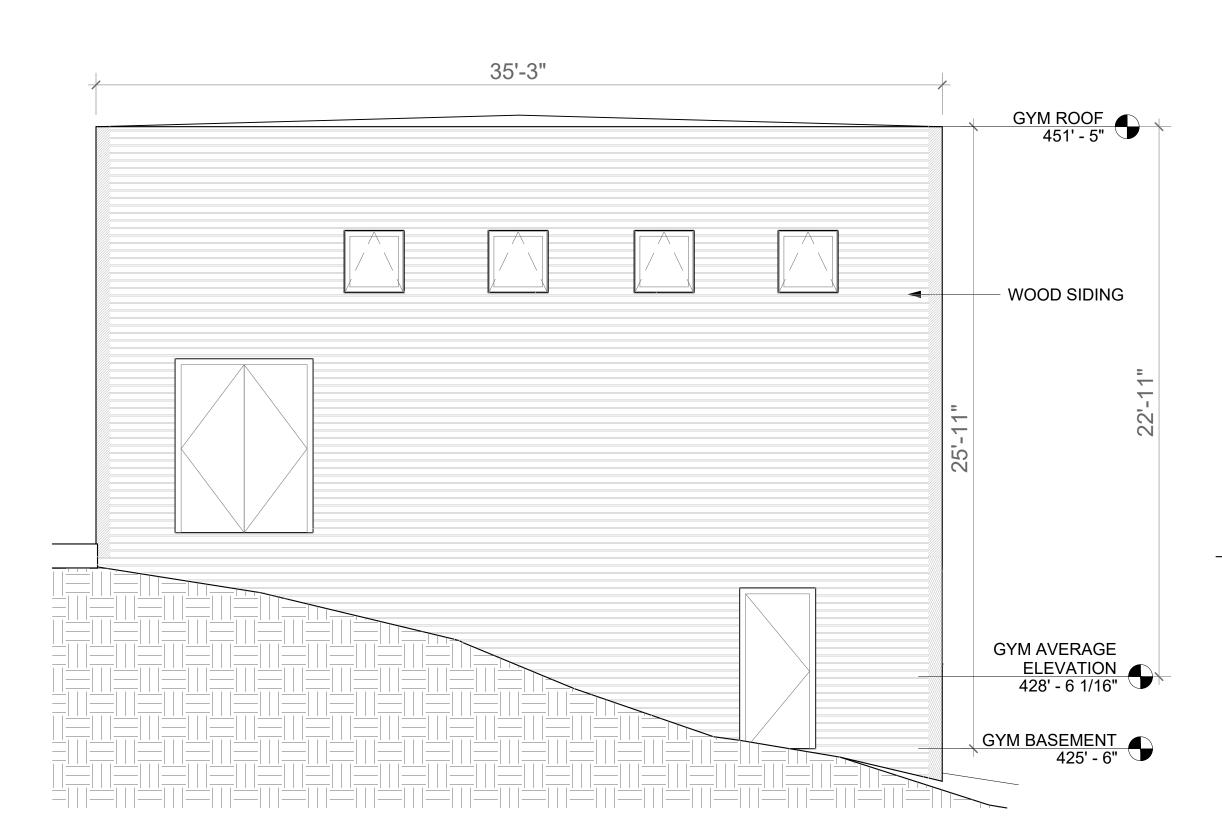

60'-2" - WOOD SIDING

GYMNASIUM - NORTH ELEVATION

1/4" = 1'-0"

4 GYMNASION 1/4" = 1'-0" GYMNASIUM - EAST ELEVATION

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> > PROJECT

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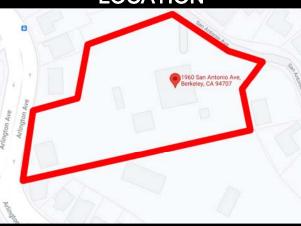
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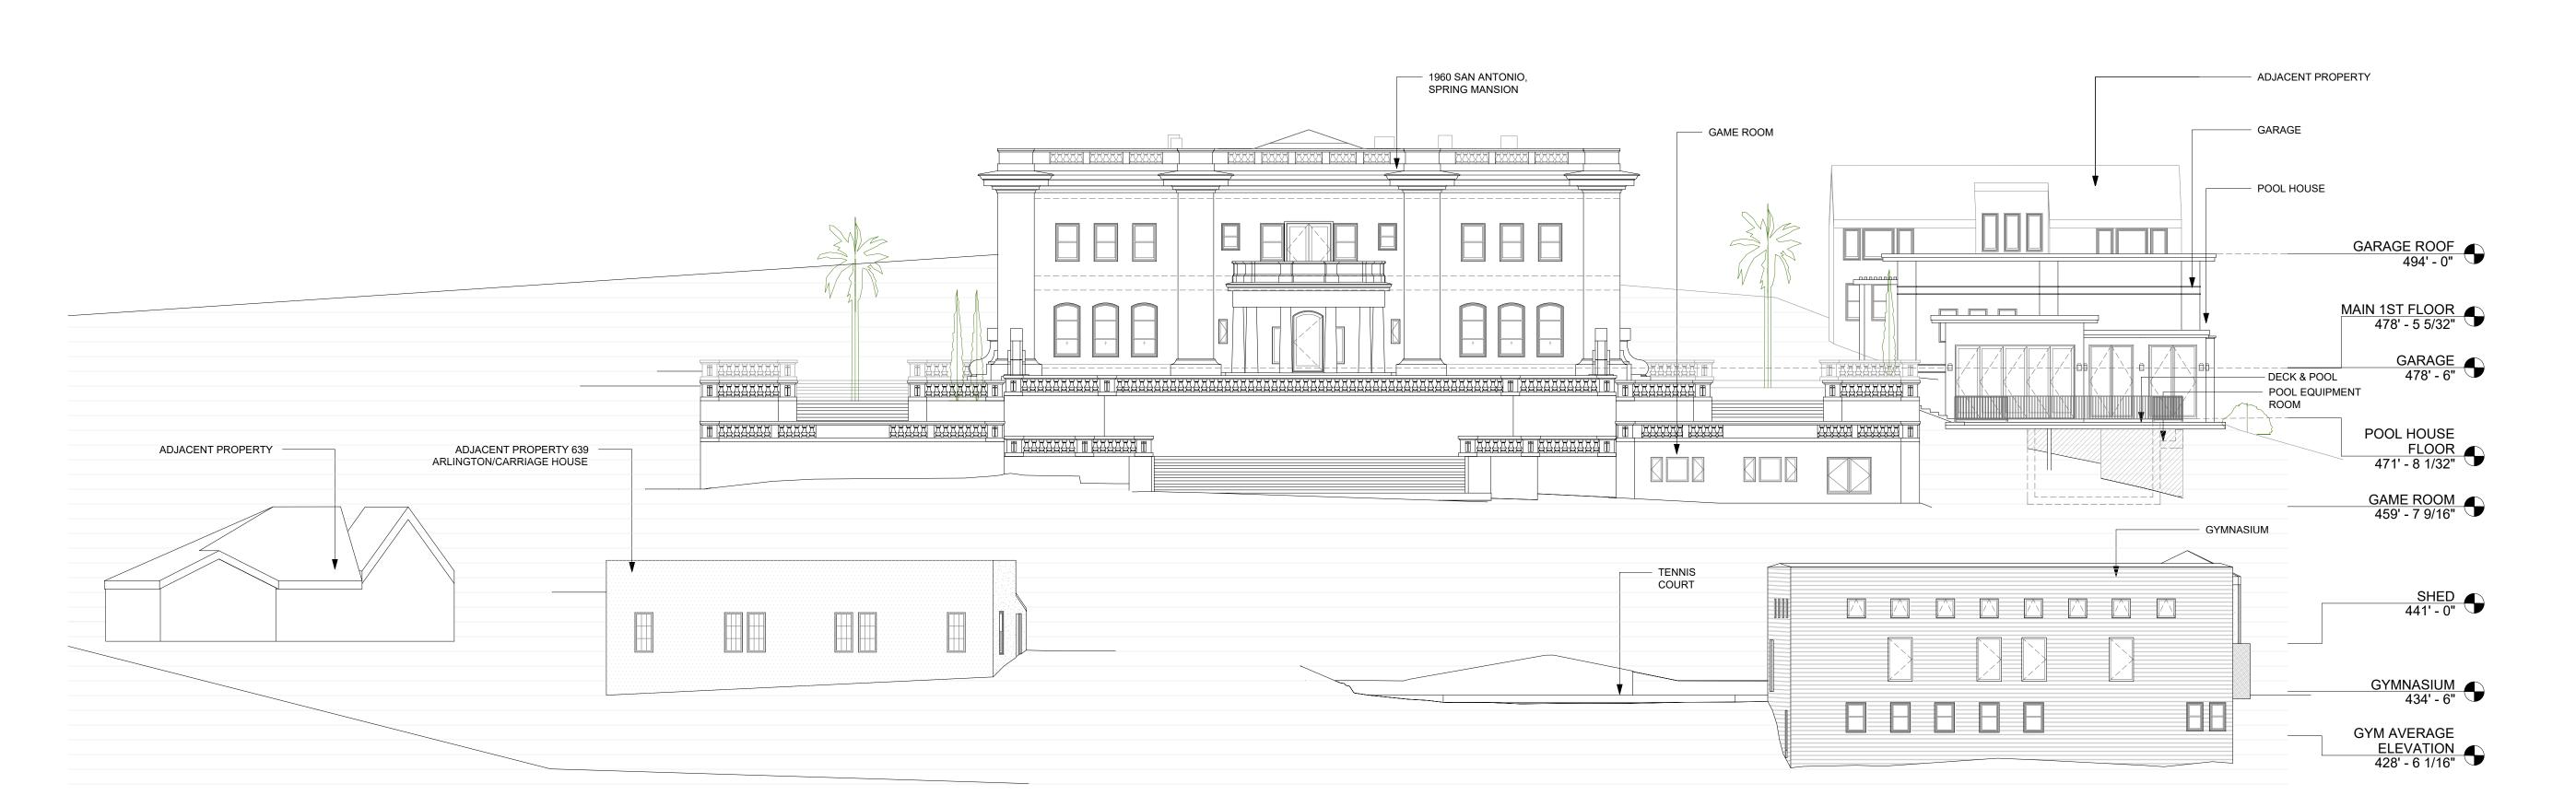
SHEET TITLE

GYMNASIUM ELEVATION **EXISTING** 


SCALE

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1 SITE SECTION FROM ARLINGTON AVE - EXISTING 1/12" = 1'-0"



2 SITE SECTION FROM ARLINGTON AVE - PROPOSED 1/12" = 1'-0"

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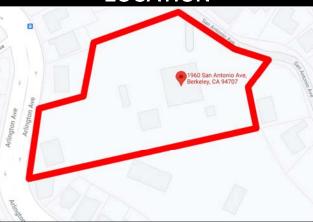
ABBAS MASH

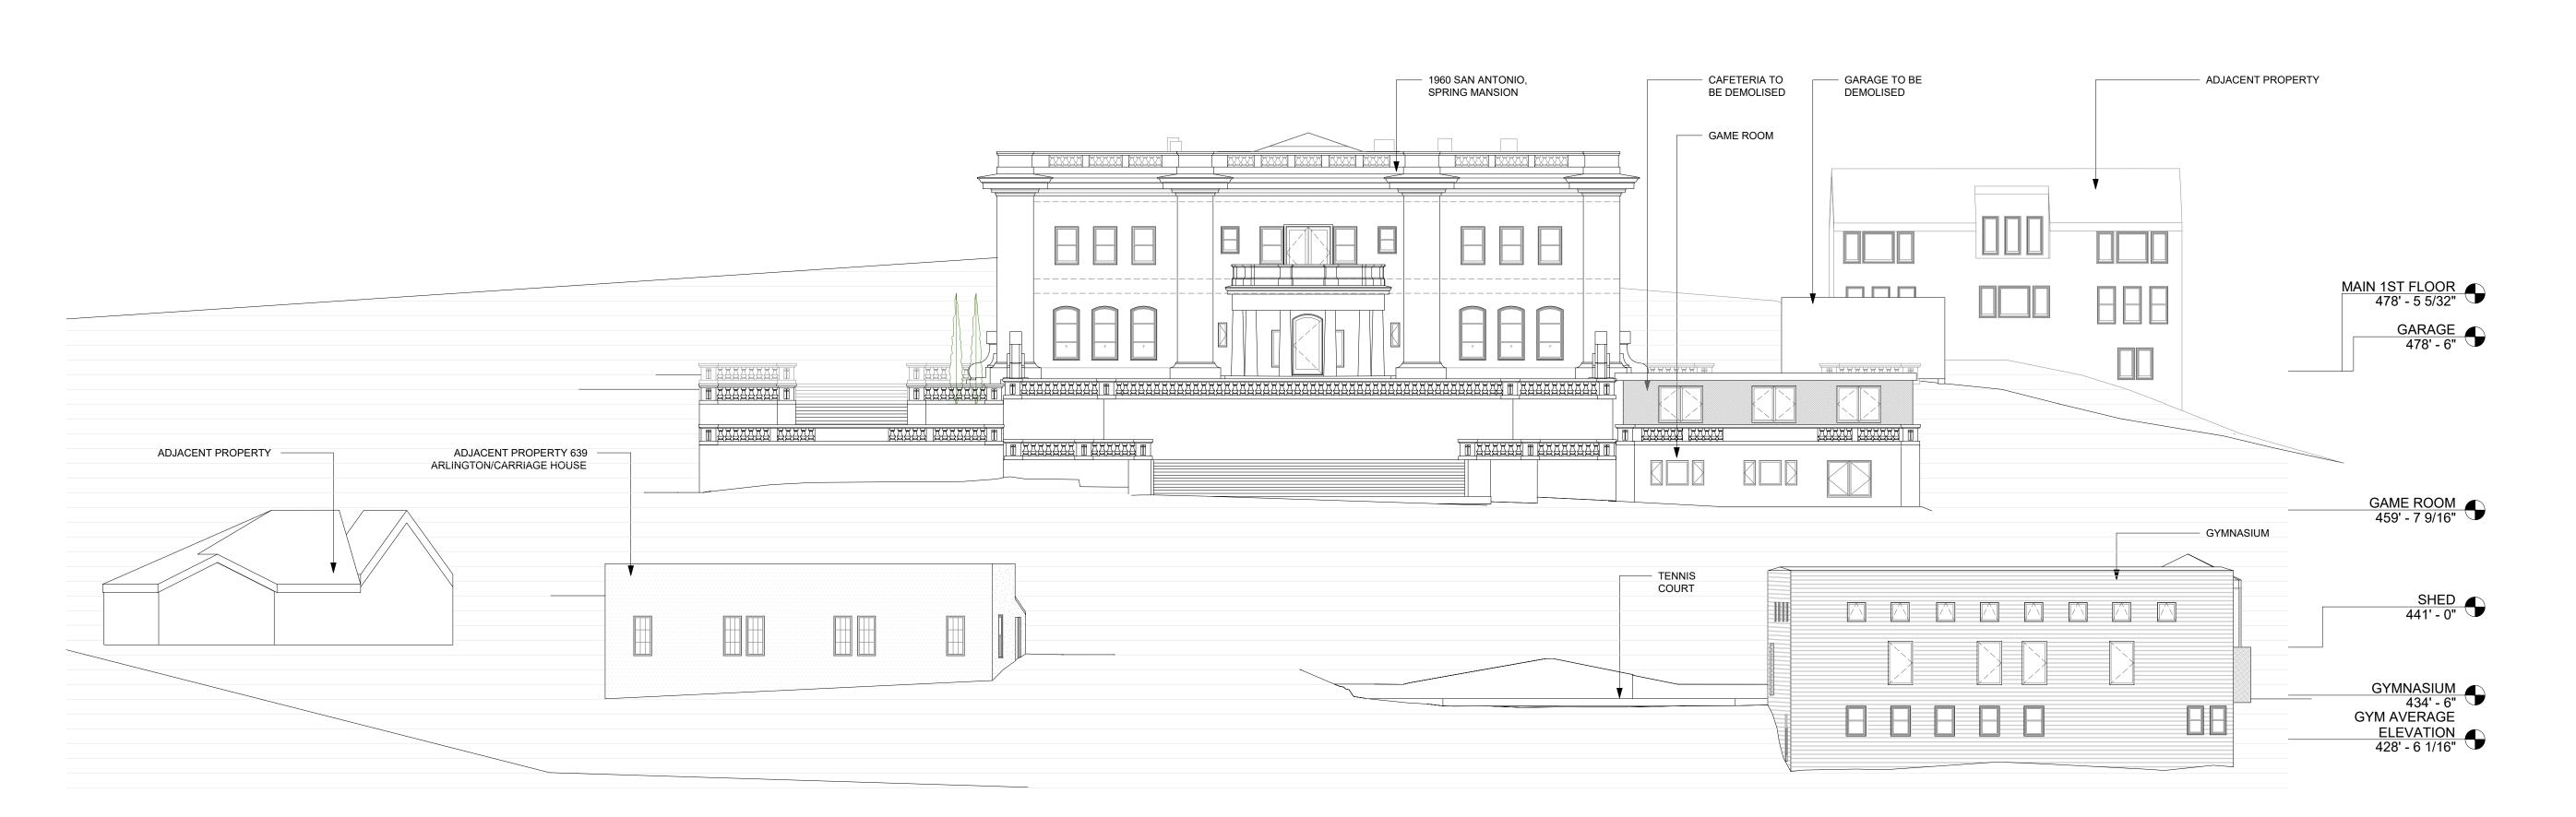REVISION DATE

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NOTES

LOCATION




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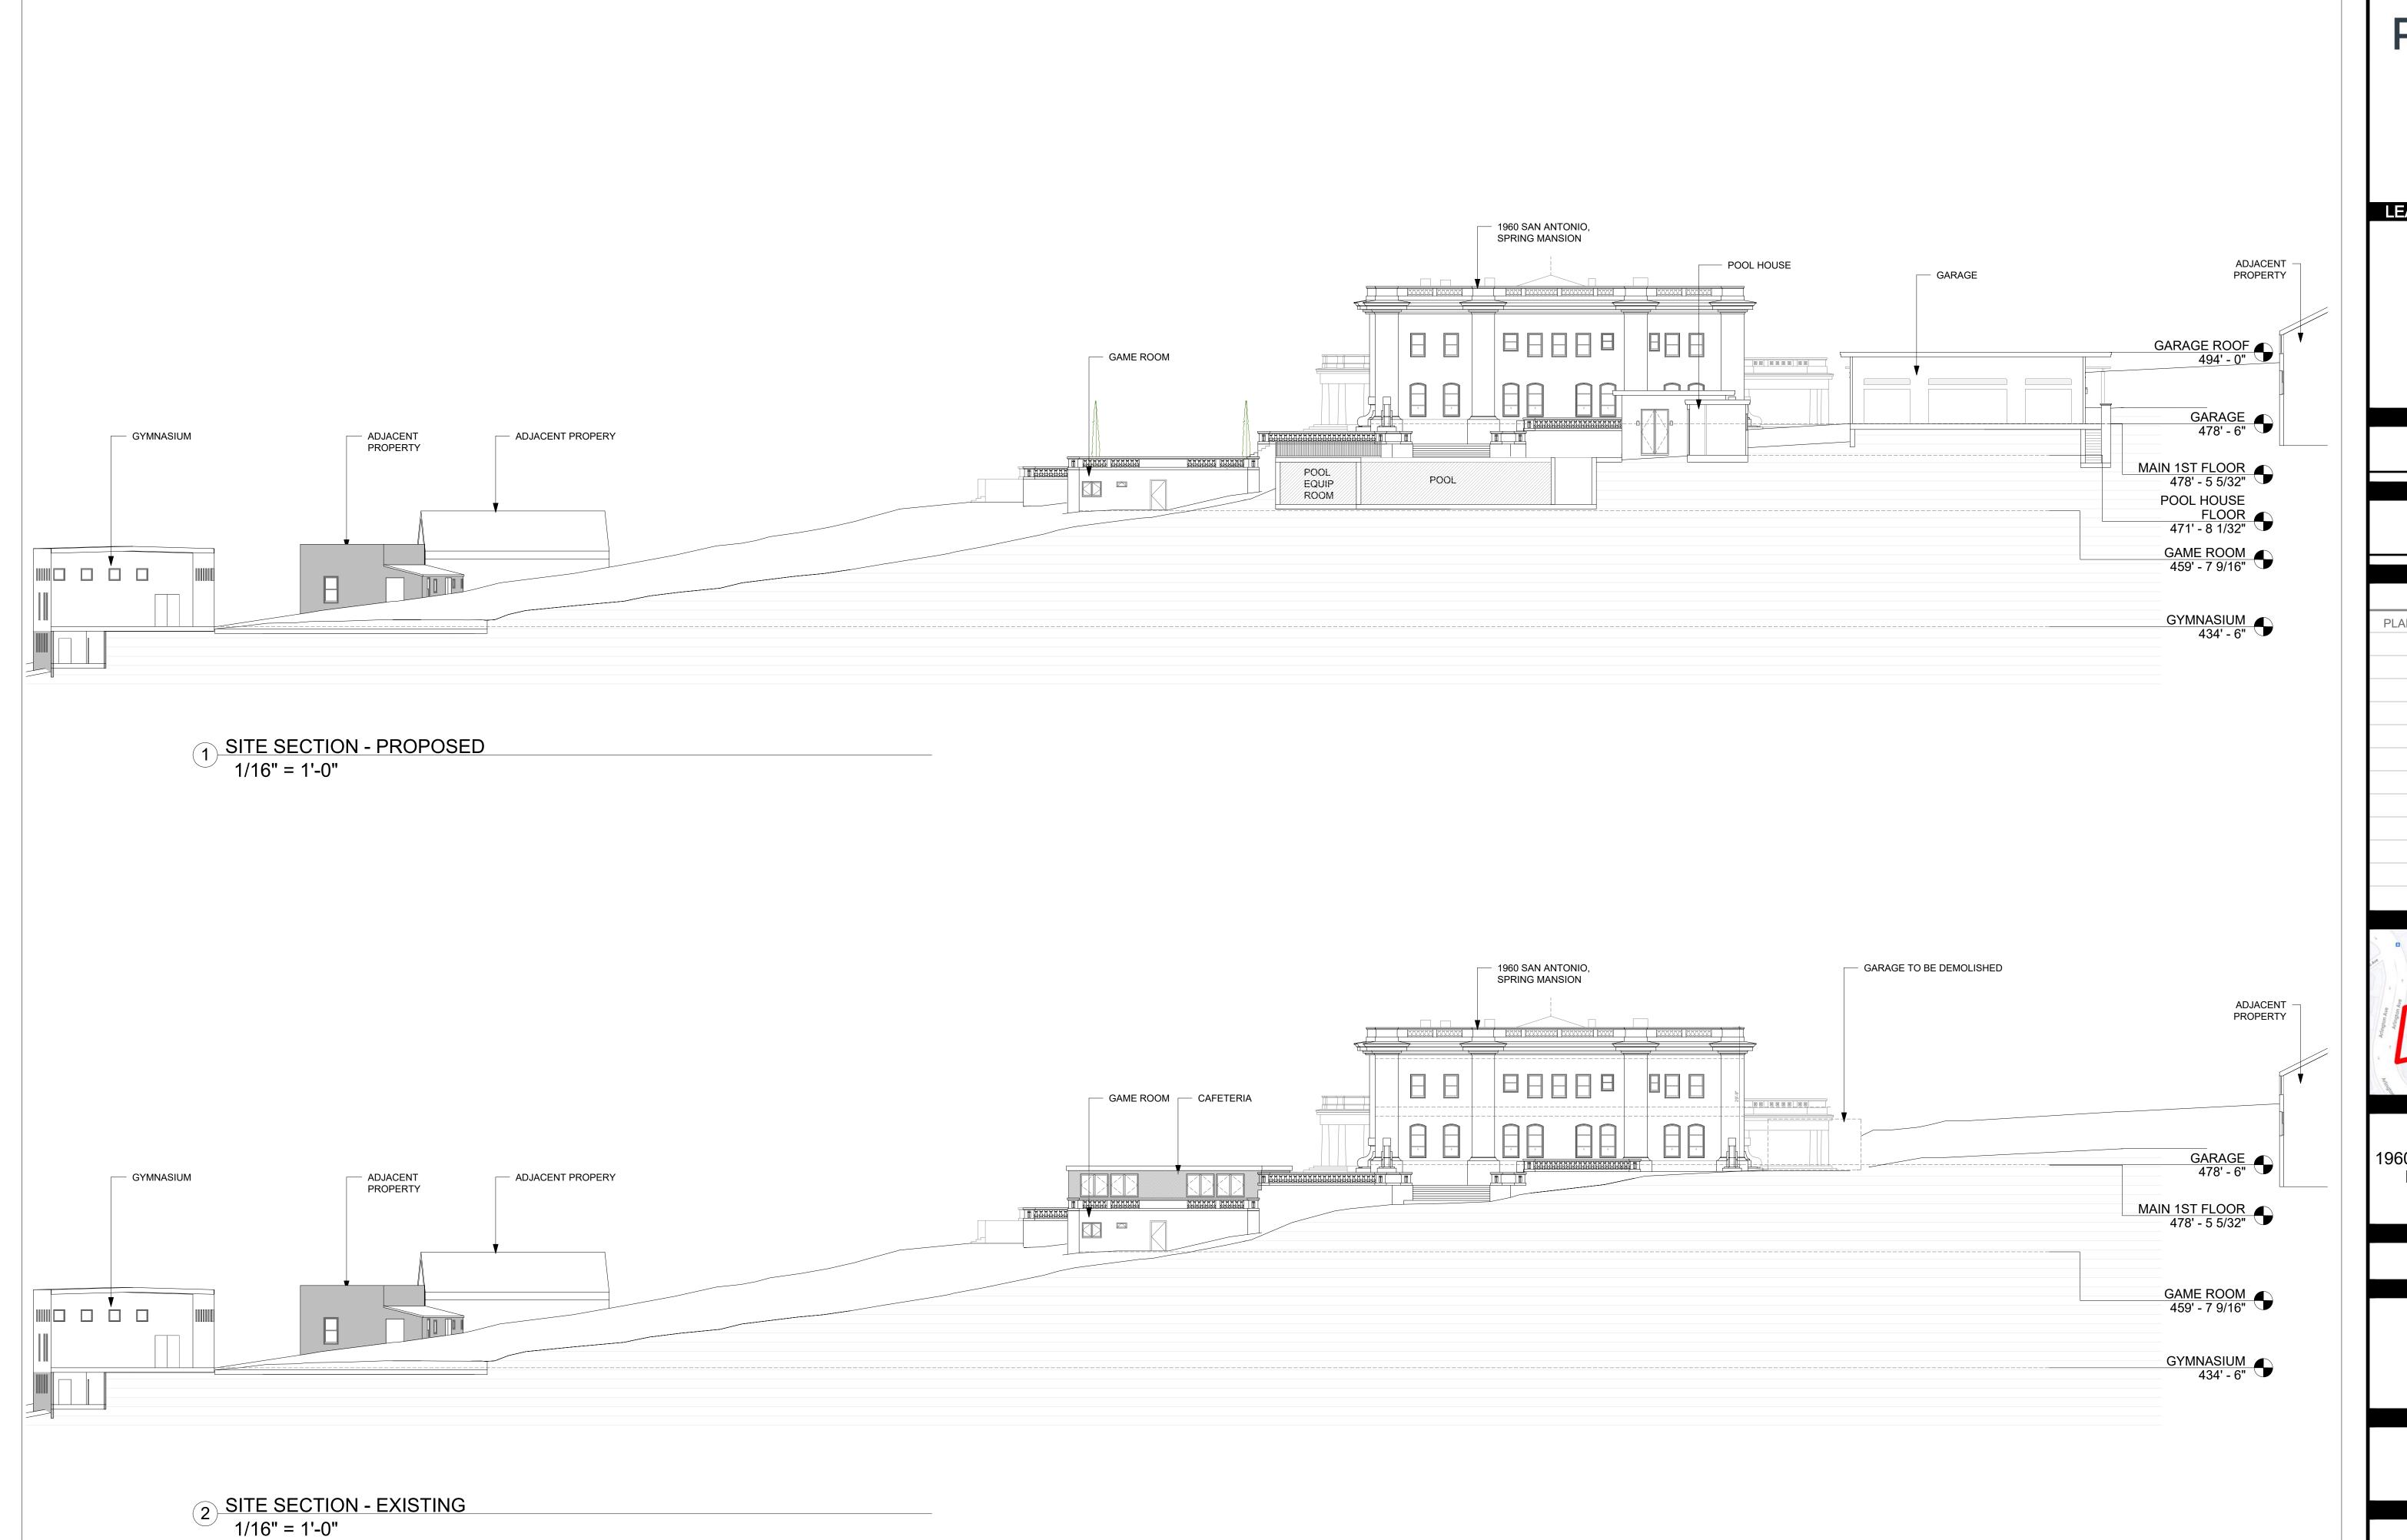
SHEET TITLE

SITE SECTIONS

SCALE

AS INDICATED

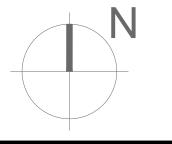SHEET NUMBER



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LEAD DESIGN CONSULTANT

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ABBAS MASH

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1960 San Antonio Ave,
Berkeley, CA 94707

ADDRESS

1960 SAN ANTONIO AVENUE BERKELEY, CA 94707

AREA

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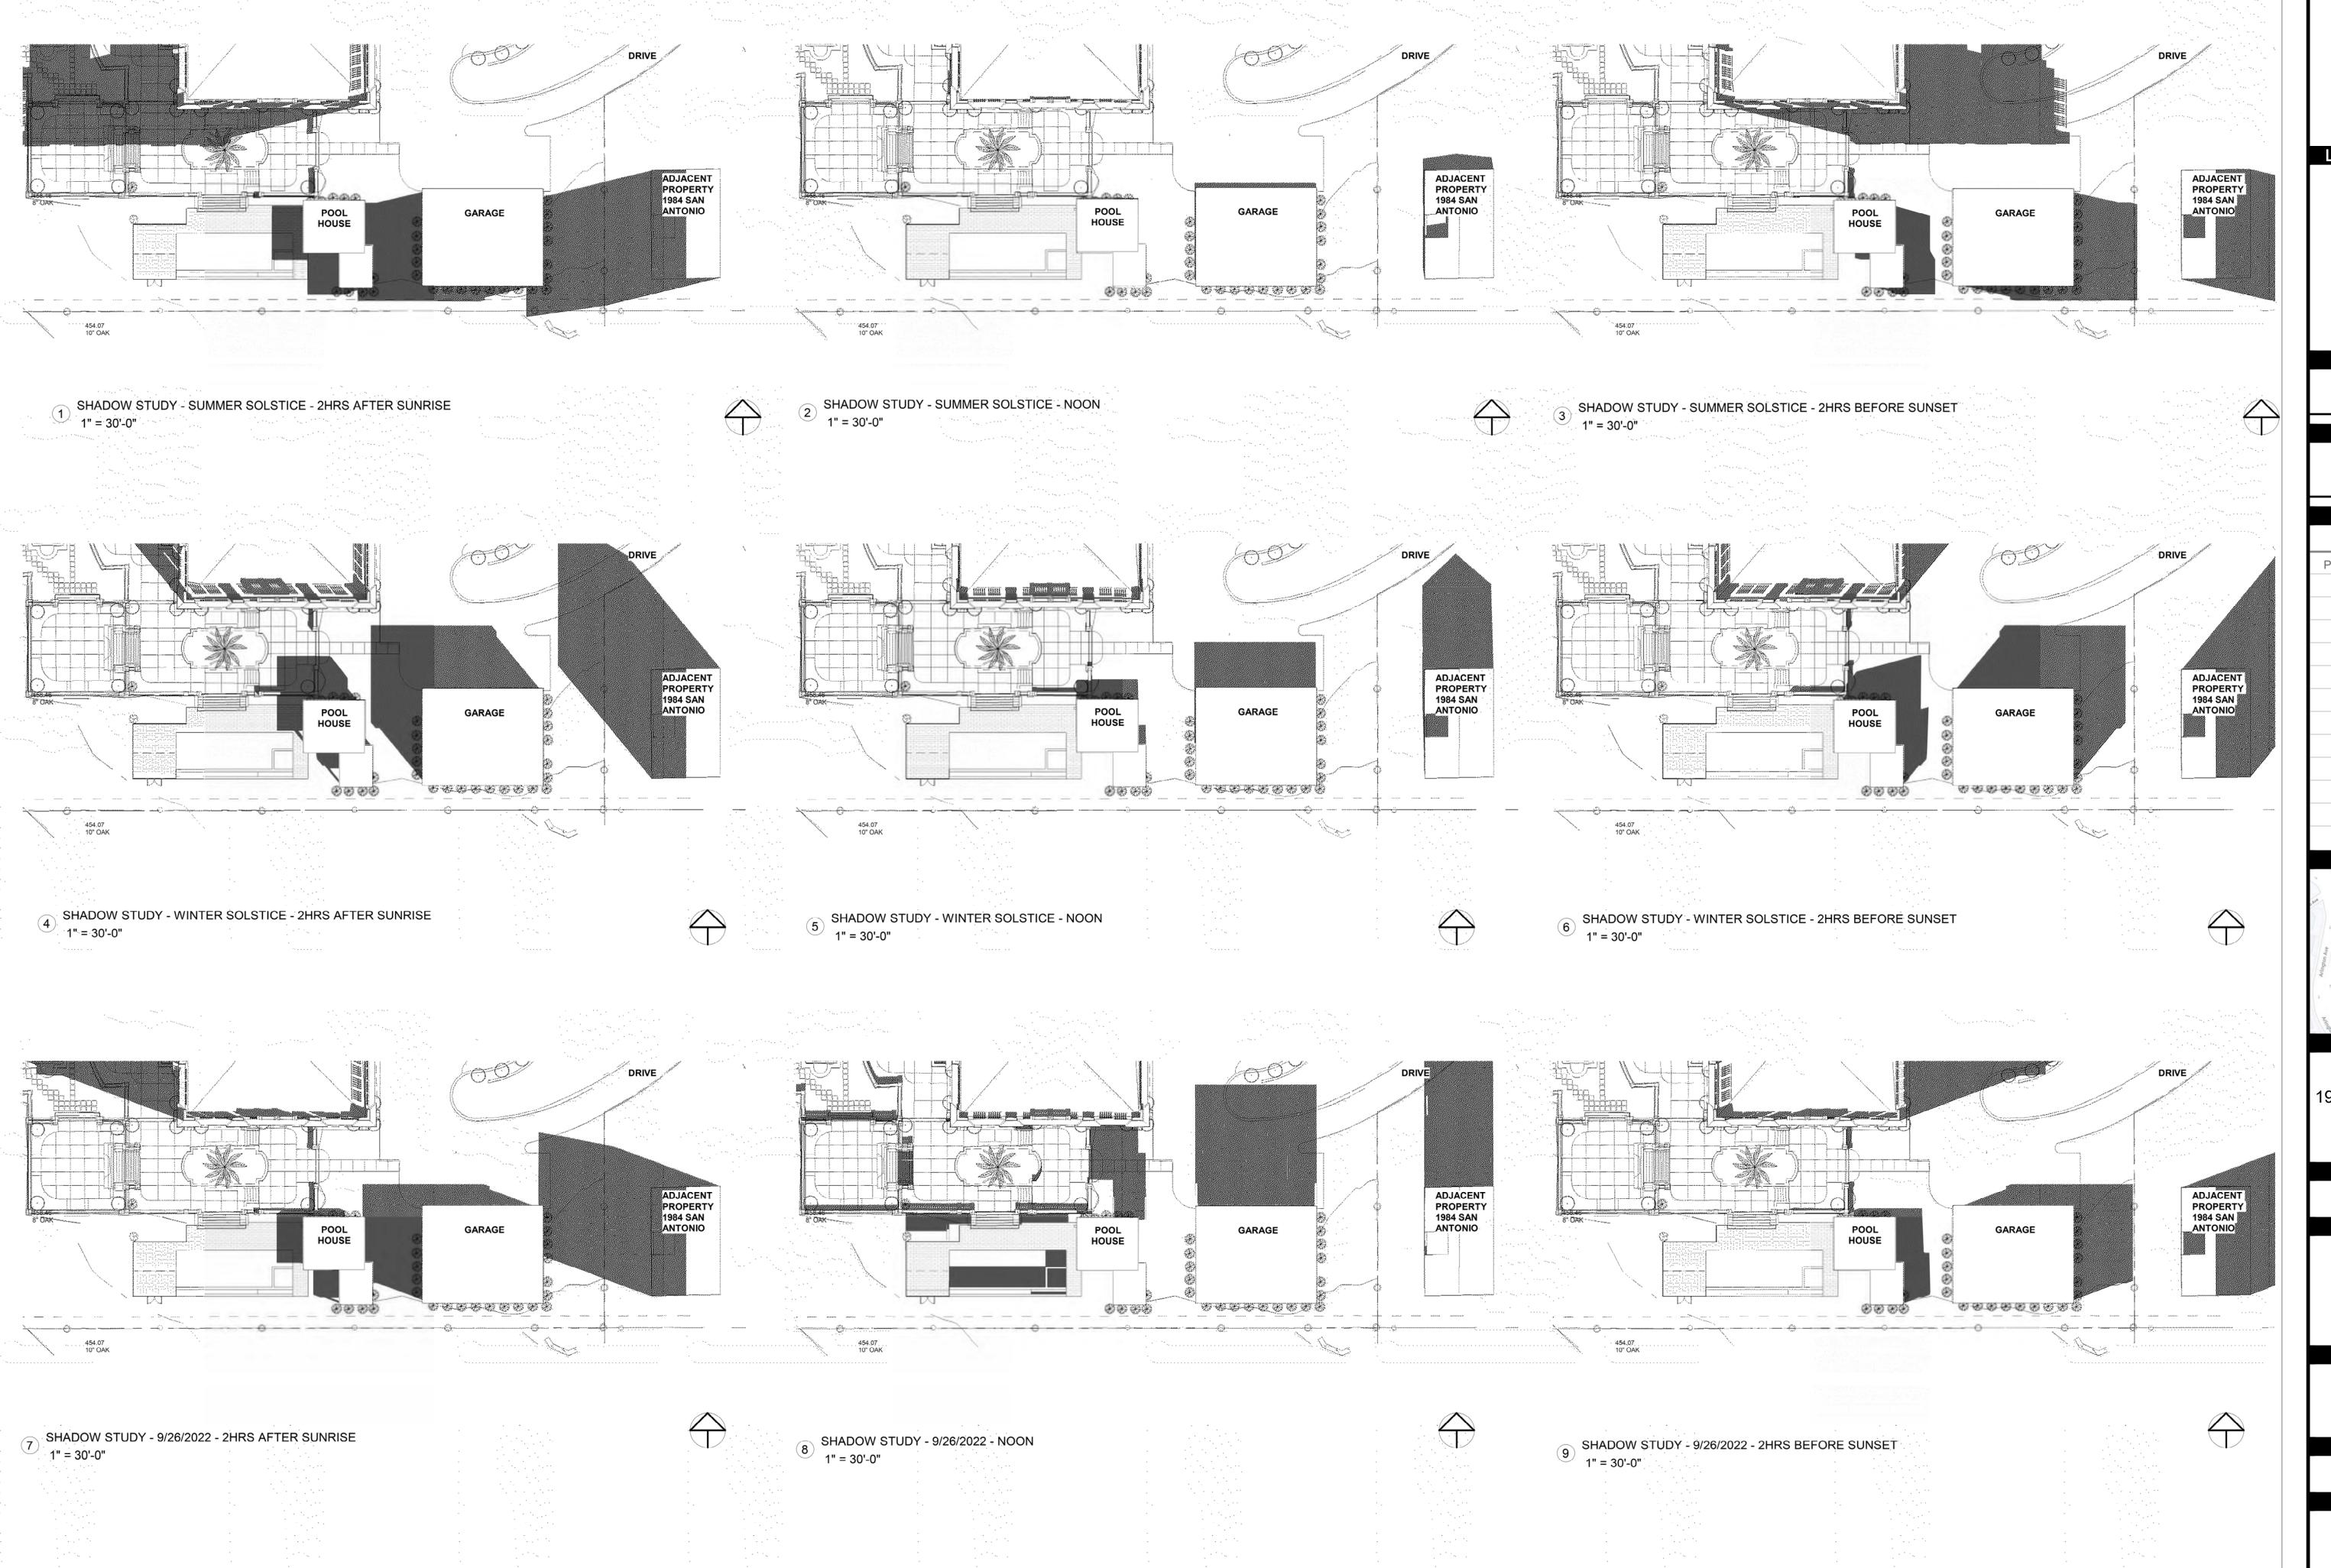
SHEET TITLE

SITE SECTIONS

SCALE

AS INDICATED

SHEET NUMBER



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DESIGNER & DRAFTER : SADAF DAYLAMI

PROJECT

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OWNER(S)


ABBAS MASH

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AREA

ORIENTATION

SHEET TITLE

SHADOW STUDY

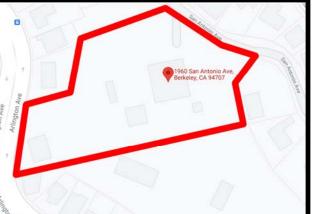SCALE

AS INDICATED

SHEET NUMBER













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#### LEAD DESIGN CONSULTANT

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DESIGNER & DRAFTER : SADAF DAYLAMI

PROJECT

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**ADDRESS** 

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AREA

ORIENTATION

SHEET TITLE

GARAGE AND POOL HOUSE RENDERING

SCALE

AS INDICATED

SHEET NUMBER